

To: Departments Concerned

From: Joshua Bednarek Date: March 17, 2025

Planning & Development Department Director

Subject: P.H.O. APPLICATION NO. PHO-1-25--Z-12-22-7 – Notice of

Pending Actions by the **Planning Hearing Officer**

1. Your attention is called to the fact that the <u>Planning Hearing Officer</u> will consider the following case at a public hearing on **April 16, 2025**.

- 2. Information about this case is available for review at the Zoning Counter in the Planning and Development Department on the 2nd Floor of Phoenix City Hall, telephone 602-262-7131, Option 6.
- Staff, please indicate your comments and respond electronically to pdd.pho@phoenix.gov or you may provide hard copies at the Zoning Counter in the Planning and Development Department on the second floor of Phoenix City Hall by <u>April 23, 2025</u>.

DISTRIBUTION

Mayor's Office (Tony Motola), 11th Floor

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Village Planner (Naveli Sanchez Luna, Laveen Village)

Village Planning Committee Chair (Stephanie Hurd, Laveen Village)



PLANNING & DEVELOPMENT DEPARTMENT

APPLICATION FOR PLANNING HEARING OFFICER ACTION APPLICATION NO: PHO-1-25--Z-12-22-7 Council District: 7

Request For: Stipulation Modification

Reason for Request: Request to modify Stipulation 2 regarding review of conceptual elevations.

Contact Information

	Somast information							
Name	Relationship Type	Address	Phone	Fax	Email			
Ashton Woods Arizona	Owner	8655 East Via De Ventura, Suite F-250, Scottsdale, AZ 85258	4806213598		melissa.vasquez@ashtonwoods .com			
Melissa Vasquez, Ashton Woods Arizona	Applicant	8655 East Via De Ventura, Suite F-250, Scottsdale, AZ 85258			melissa.vasquez@ashtonwoods .com			
Melissa Vasquez, Ashton Woods Arizona	Representative	8655 East Via De Ventura, Suite F-250, Scottsdale, AZ 85258			melissa.vasquez@ashtonwoods .com			

Property Location: Northwest corner of 47th Avenue and Baseline Road

Acreage: 14.07

Geographic Information

Zoning Map APN Quarter Section

D5 104-89-004R Q1-17

Village: Laveen

An applicant may receive a clarification from the city of its interpretation or application of a statute, ordinance, code or authorized substantive policy statement. To request clarification or to obtain further information on the application process and applicable review time frames, please call 602-262-7131 (option 6), email zoning@phoenix.gov or visit our website at https://www.phoenix.gov/pdd/licensing-time-frames

A Filing Fee had been paid to the City Treasurer to cover the cost of processing this application. The fee will be retained to cover the cost whether or not the request is granted

I declare that all information submitted is true and correct to the best of my knowledge and belief. I acknowledge that any error in my application may be cause for changing its normal scheduling.

Signature:	DATE:	

ree information						
Fee	Fee Waived	Fee Date	Purpose			
\$1,080.00	\$0.00	03/10/25	PHO (1-2 stipulations)			



City of Phoenix Planning & Development Department 200 W. Washington St., 3rd Floor Phoenix, AZ 85003

RE: PHO-4-25

Dear Planning & Zoning,

Per Stipulation 2 in zoning approval Z-12-22, Ashton Woods (buyer) is to submit conceptual elevations for review and approval by the Planning Hearing Officer (PHO) prior to approval of the Single-Family Design Review Diversity Exhibit. This request is for PHO to review an approve our conceptual elevations.

The elevations have been designed to adhere to Stipulation 2, Sections A-E. There are six plan offerings with three elevation styles each, including Spanish, Craftsman, Farmhouse, and Modern Desert. The non-Spanish elevation have a minimum of 25% non-stucco accent material, with mixed use of wood, rough sawn posts, stone veneer, and stucco. Garage doors have been enhanced with decorative stucco popouts and paneling. The homes also offer covered porches and patios, with 75% of the offerings having a minimum of 60 square feet.

Respectfully,

Melissa Vasquez Director of Architecture

Official Records of Maricopa County Recorder
STEPHEN RICHER
20220596299 07/25/2022 03:08
ELECTRONIC RECORDING
6999G-7-1-1--

ORDINANCE G-6999

AN ORDINANCE AMENDING THE ZONING DISTRICT MAP ADOPTED PURSUANT TO SECTION 601 OF THE CITY OF PHOENIX ZONING ORDINANCE BY CHANGING THE ZONING DISTRICT CLASSIFICATION FOR THE PARCEL DESCRIBED HEREIN (CASE Z-12-22-7) FROM S-1 (RANCH OR FARM RESIDENCE DISTRICT) TO R1-18 (SINGLE-FAMILY RESIDENCE DISTRICT).

BE IT ORDAINED BY THE COUNCIL OF THE CITY OF PHOENIX, as follows:

SECTION 1. The zoning of a 14.07 acre property located on the northwest corner of 47th Avenue and Baseline Road in a portion of Section 33, Township 1 North, Range 2 East, as described more specifically in Exhibit "A," is hereby changed from "S-1" (Ranch or Farm Residence District), to "R1-18" (Single-Family Residence District).

SECTION 2. The Planning and Development Director is instructed to modify the Zoning Map of the City of Phoenix to reflect this use district classification change as shown in Exhibit "B."

SECTION 3. Due to the site's specific physical conditions and the use district applied for by the applicant, this rezoning is subject to the following stipulations, violation of which shall be treated in the same manner as a violation of the City of Phoenix Zoning Ordinance:

1. The development shall be in general conformance to the site plan date

stamped May 4, 2022, with specific regard to the following element, as approved by the Planning and Development Department.

- a. A minimum of 16% of the gross site area shall be retained as open space.
- The conceptual elevations shall be reviewed and approved by the Planning Hearing Officer through the public hearing process for stipulation modification prior to approval of the Single-Family Design Review Diversity Exhibit, with specific regard to the inclusion of the below elements. This is legislative review for conceptual purposes only. Specific development standards and requirements will be determined by the Planning Hearing Officer and the Planning and Development Department.
 - All elevations shall incorporate a minimum of three of the following architectural embellishments and detailing: textural changes, pilasters, offsets, recesses, variation in window size and location, and/or overhang canopies.
 - All elevations shall incorporate a minimum of three of the following building materials: native stone, burnt adobe, textured brick, wood (when shaded by overhangs or deep recesses), slump block, ceramic tile (matte finish), stucco, and/or exposed aggregate concrete.
 - The front elevations shall consist of a minimum 25% non-stucco accent material.
 - d. All garage doors shall have decorative embellishments such as window panels, added materials surrounding the door, and/or trellises.
 - A minimum of 75% of the standard elevations provided shall include patios and/or covered porches in the front yard at a minimum of 60 square feet in area and a depth of at least six feet, and clearly separated from the front yard with fencing, subject to the Phoenix Zoning Ordinance.
- 3. Lots 7, 8, 9, and 10 along Baseline Road shall be limited to 26 feet, as approved by the Planning and Development Department.
- 4. No more than two two-story homes shall be built adjacent to one another along 47th Avenue, as approved by the Planning and Development Department.
- 5. Homes shall have minimum 5-foot-wide side yard setbacks.

- 6. The developer shall install wiring within homes for electric vehicle capabilities.
- 7. Required landscape setbacks shall be planted with minimum 50% 2-inch caliper and 50% 3-inch caliper large canopy drought-tolerant trees, 20 feet on center or in equivalent groupings, with 5-gallon shrubs per tree, as approved by the Planning and Development Department.
- 8. The entry drives shall incorporate enhanced landscaping on both sides, planted with a variety of at least three plant materials, as approved by the Planning and Development Department.
- 9. The developer shall dedicate a 30-foot-wide multi-use trail easement (MUTE) along the north side of Baseline Road and construct a minimum 10-foot-wide multi-use trail (MUT) within the easement in accordance with the MAG supplement detail and as approved by the Planning and Development Department. Where conflicts or restrictions exist, the developer shall work with the Site Planning section on an alternate design through the technical appeal process.
- 10. A minimum 22-foot setback shall be provided to the front of garages, measured from the back of the sidewalk, for each home in the development, as approved by the Planning and Development Department.
- 11. The developer shall dedicate 30 feet of right-of-way along the west side of 47th Avenue, as approved by the Planning and Development Department.
- 12. The developer shall complete the west side of 47th Avenue to include a minimum 5-foot-wide detached sidewalk and minimum 8-foot-wide landscape area located between the back of curb and sidewalk to match the northern limit of the site, as approved by the Planning and Development Department.
- 13. The developer shall replenish the existing streetscape along Baseline Road, as approved by the Planning and Development Department.
- 14. Where sidewalks are detached along 47th Avenue, Baseline Road, and internal to the site, the landscape area located between the sidewalk and back of curb shall be planted to the following standards, as approved by the Planning and Development Department:
 - a. Minimum 3-inch caliper, large canopy, single-trunk, shade trees placed a minimum of 25 feet on center or in equivalent groupings to provide a minimum of 75% shade on adjacent sidewalks.
 - b. Drought tolerant shrubs and vegetative groundcovers with a

- maximum mature height of 24 inches to provide a minimum of 75% live coverage at maturity.
- c. Where utility conflicts arise, the developer shall work with the Planning and Development on an alternative design solution consistent with a pedestrian environment.
- 15. The developer shall construct a clearly defined and shaded pedestrian pathway providing access to the multi-use-trail along Baseline Road, as approved by the Planning and Development Department.
- 16. Traffic calming measures shall be installed within the development, as approved by the Street Transportation Department.
- 17. The developer shall construct all streets within and adjacent to the development with paving, curb, gutter, sidewalk, curb ramps, streetlights, median islands, landscaping and other incidentals, as per plans approved by the Planning and Development Department. All improvements shall comply with all ADA accessibility standards.
- 18. The developer shall rebuild the bus stop pad along westbound Baseline Road according to P1260 and P1258, unless stated otherwise by the Public Transit Department.
- 19. If determined necessary by the Phoenix Archaeology Office, the applicant shall conduct Phase I data testing and submit an archaeological survey report of the development area for review and approval by the City Archaeologist prior to clearing and grubbing, landscape salvage, and/or grading approval.
- 20. If Phase I data testing is required, and if, upon review of the results from the Phase I data testing, the City Archaeologist, in consultation with a qualified archaeologist, determines such data recovery excavations are necessary, the applicant shall conduct Phase II archaeological data recovery excavations.
- In the event archaeological materials are encountered during construction, the developer shall immediately cease all ground-disturbing activities within a 33-foot radius of the discovery, notify the City Archaeologist, and allow time for the Archaeology Office to properly assess the materials.

SECTION 4. If any section, subsection, sentence, clause, phrase or portion of this ordinance is for any reason held to be invalid or unconstitutional by the

decision of any court of competent jurisdiction, such decision shall not affect the validity of the remaining portions hereof.

PASSED by the Council of the City of Phoenix this 1st day of July, 2022.

MAYOR

ATTEST:

Denise Archibald, City Clerk 2. 08. 2022

APPROVED AS TO FORM: Cris Meyer, City Attorney

By:

Deryck R. Lavelle, Assistant Chief Counsel

Pml

REVIEWED BY:

Jeffrey Barton, City Manager

Exhibits:

A – Legal Description (1 Page)

B - Ordinance Location Map (1 Page)

PL:tml:LF22-0853:7-1-2022:2325337v1

EXHIBIT A

LEGAL DESCRIPTION FOR Z-12-22-7


The Southeast Quarter of the Southwest Quarter of Section 33, Township 1 North, Range 2 East of the Gila and Salt River Base and Meridian, Maricopa County, Arizona;

EXCEPT the South 55 feet thereof;


EXCEPT all that portion thereof lying within the Final Plat for Rogers Ranch Parcel 9, recorded in Book 817 of Maps, Page 16;


EXCEPT all that portion thereof lying within the Final Plat of Rogers Ranch Unit 4, recorded in Book 680 of Maps, Page 24;


EXCEPT all that portion thereof lying within 47th Avenue and Baseline Road as shown on Map of Dedication for Rogers Ranch, recorded in Book 623 of Maps, Page 29.

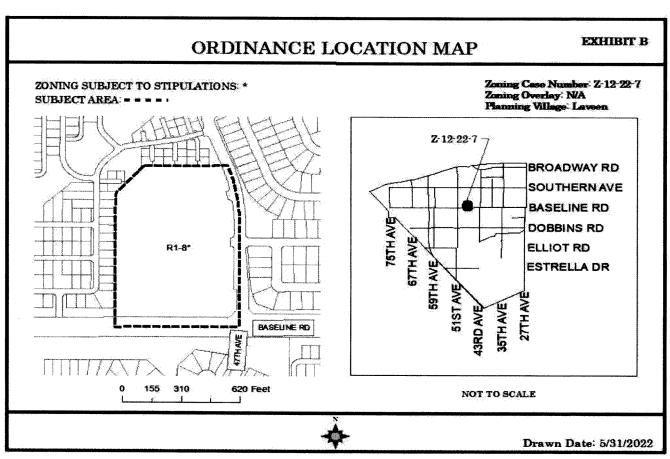



S: Cap artment Share eliabornation Systems Pt. BISHS_Teams Core_Functions Zoning Supplifage_OrdMaps 2022 Ord 7-1-22-2-12-22-7 and

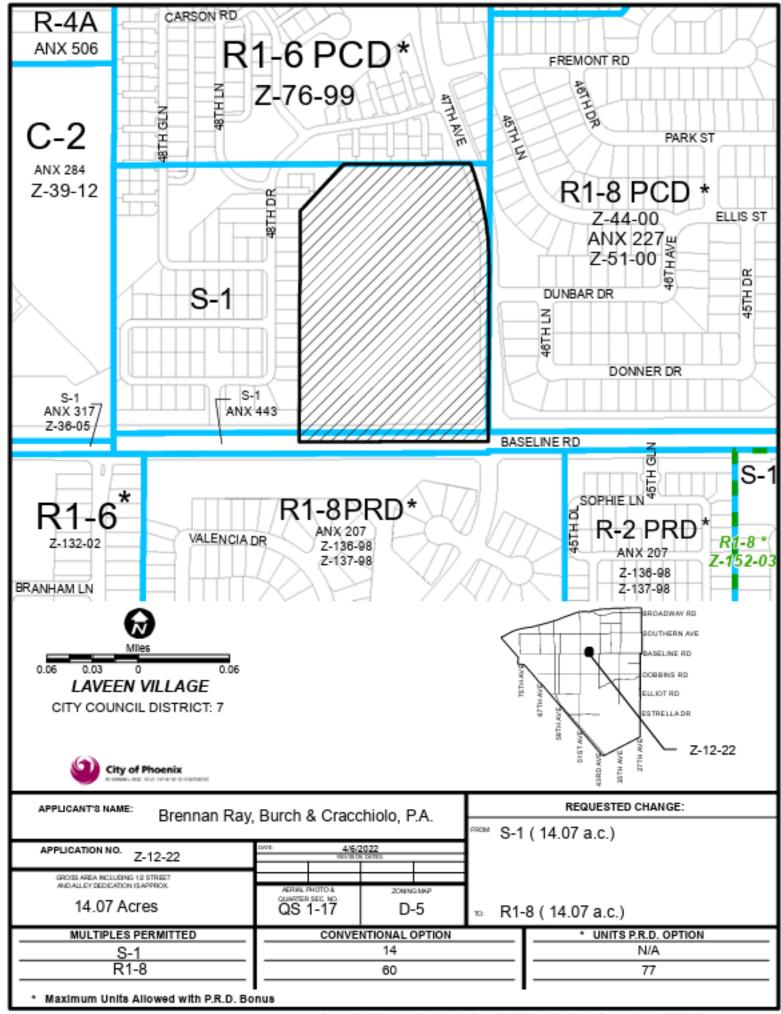


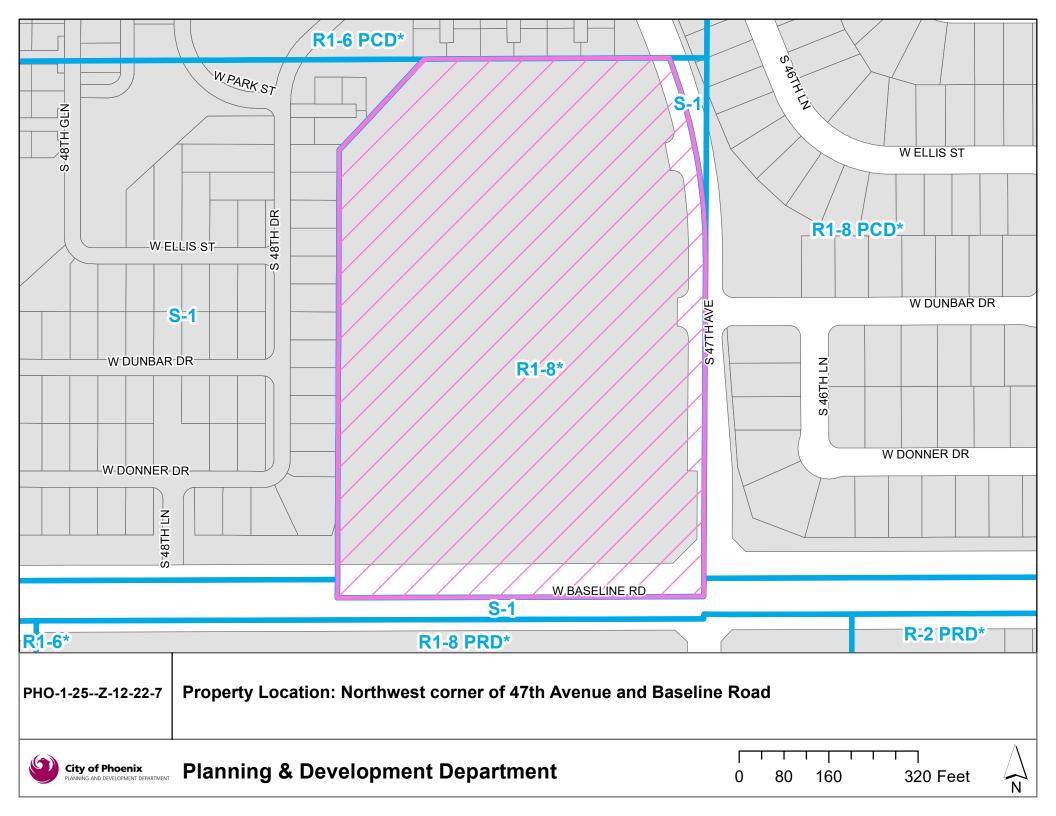

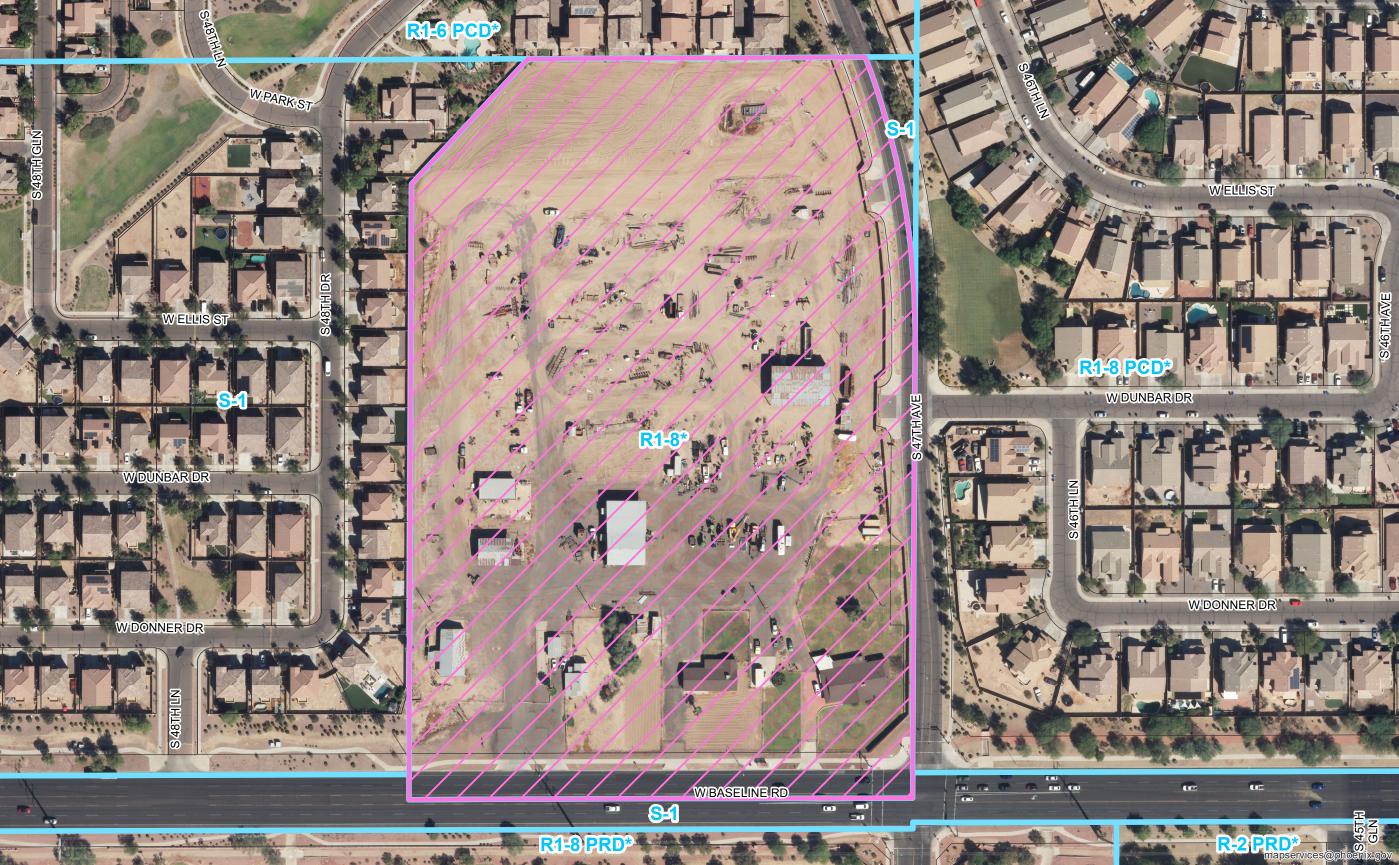

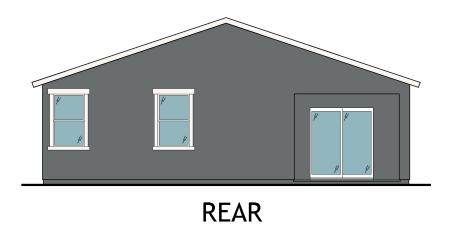

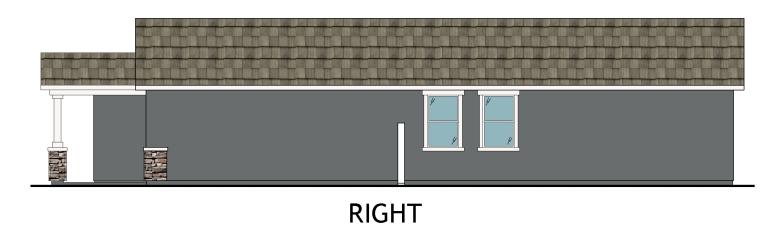

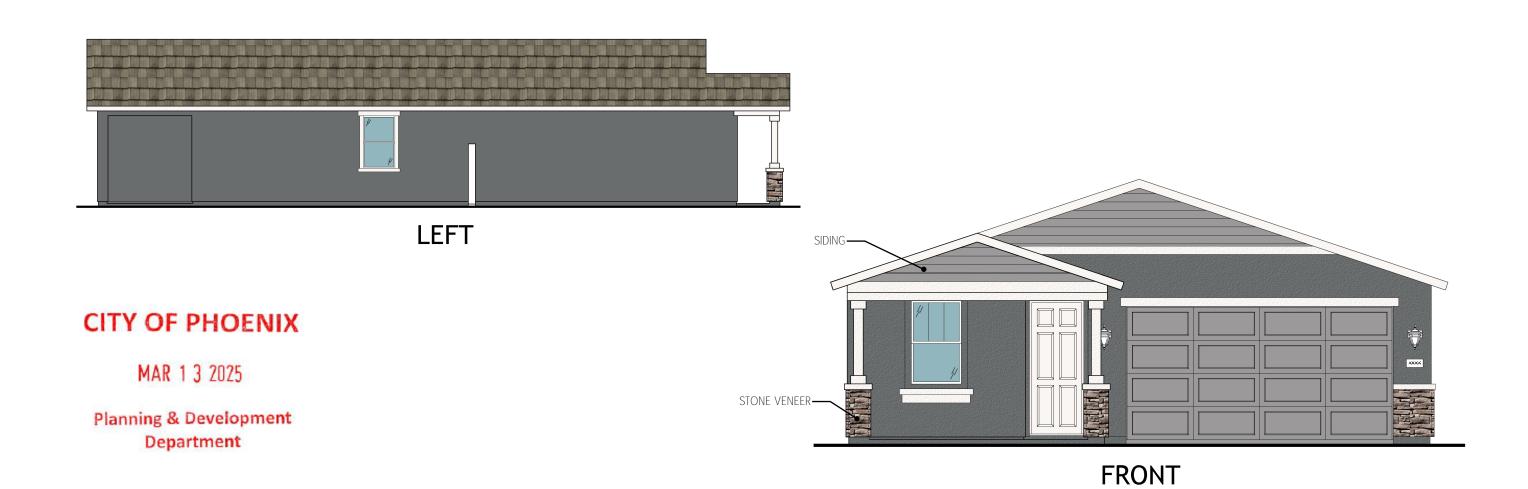





Plan 3510 - CRAFTSMAN - D2






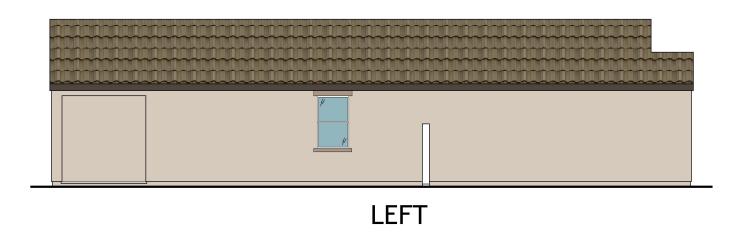

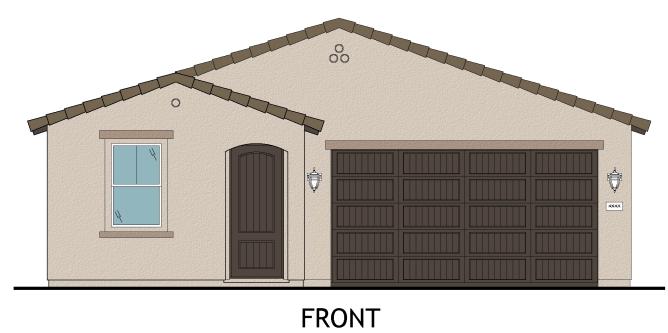




Plan 3510 - SPANISH - L2

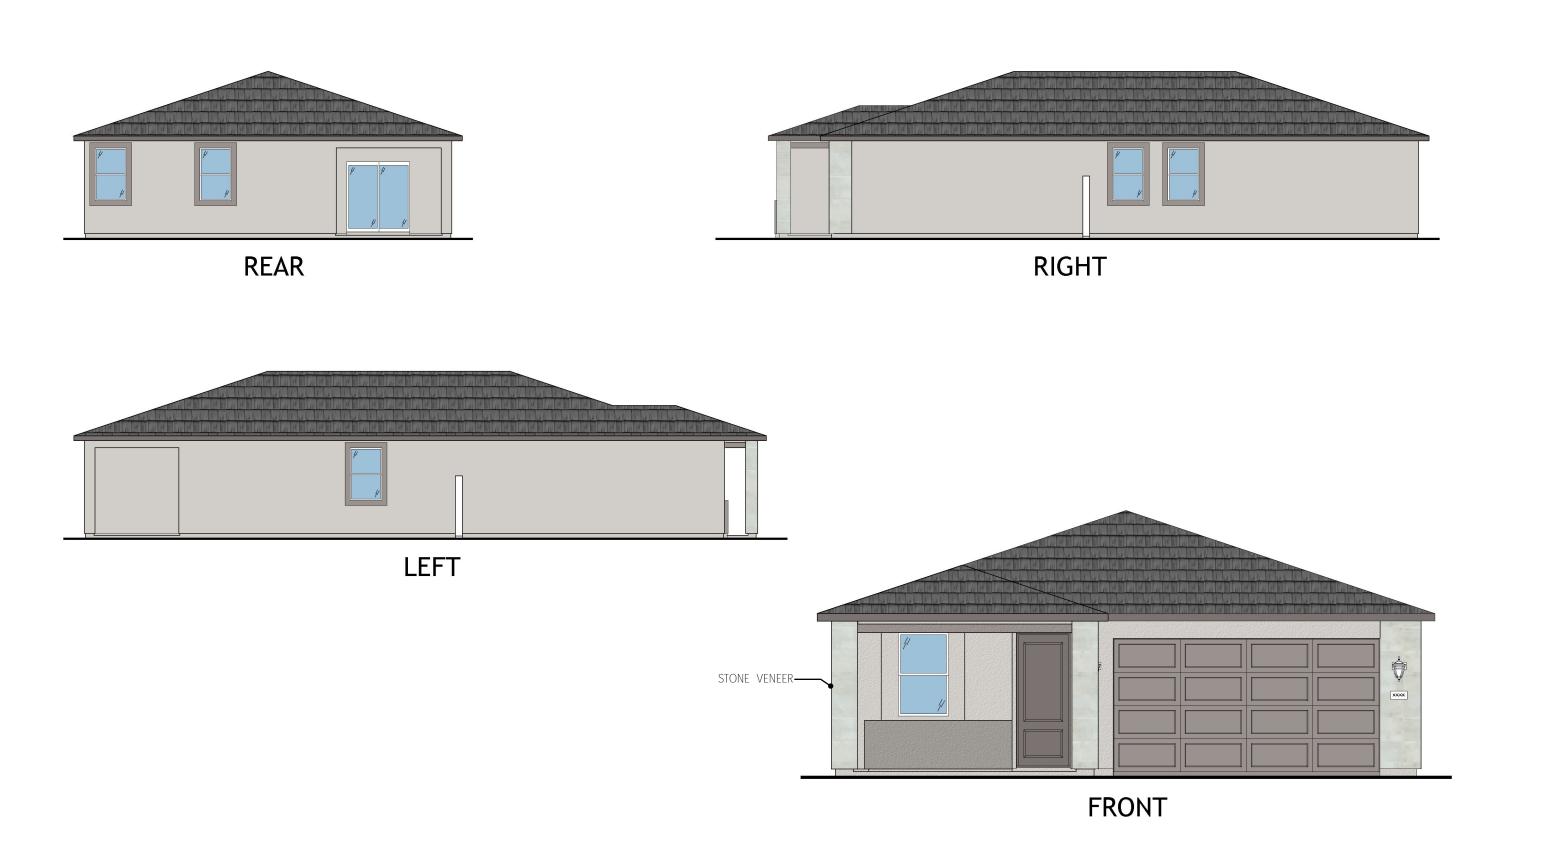




Plan 3510 - MODERN DESERT - T2

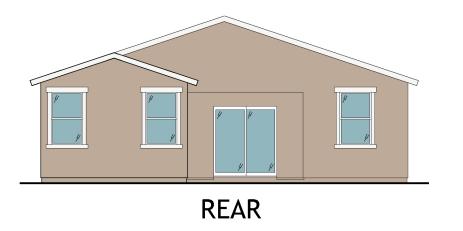





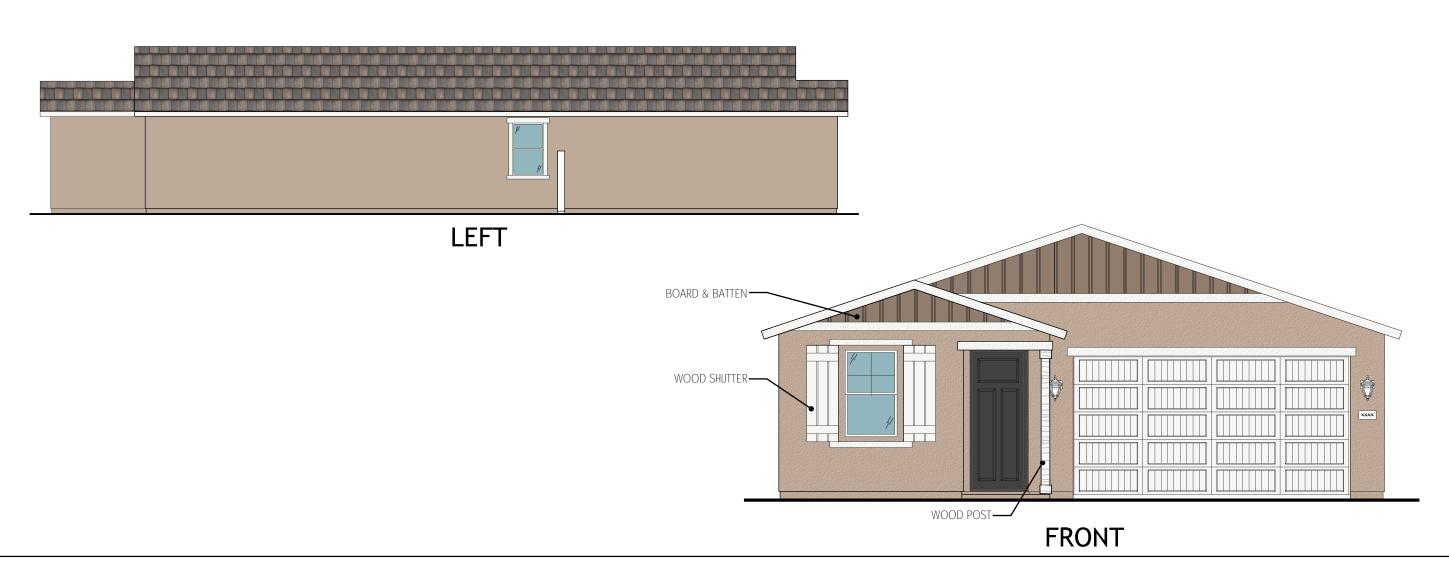




Plan 3520 - FARMHOUSE - J1

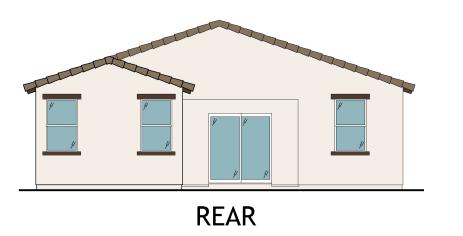


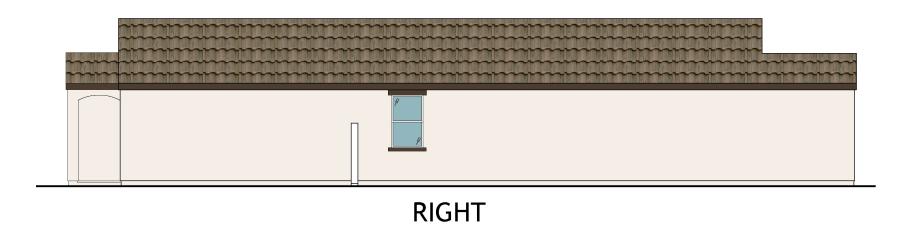


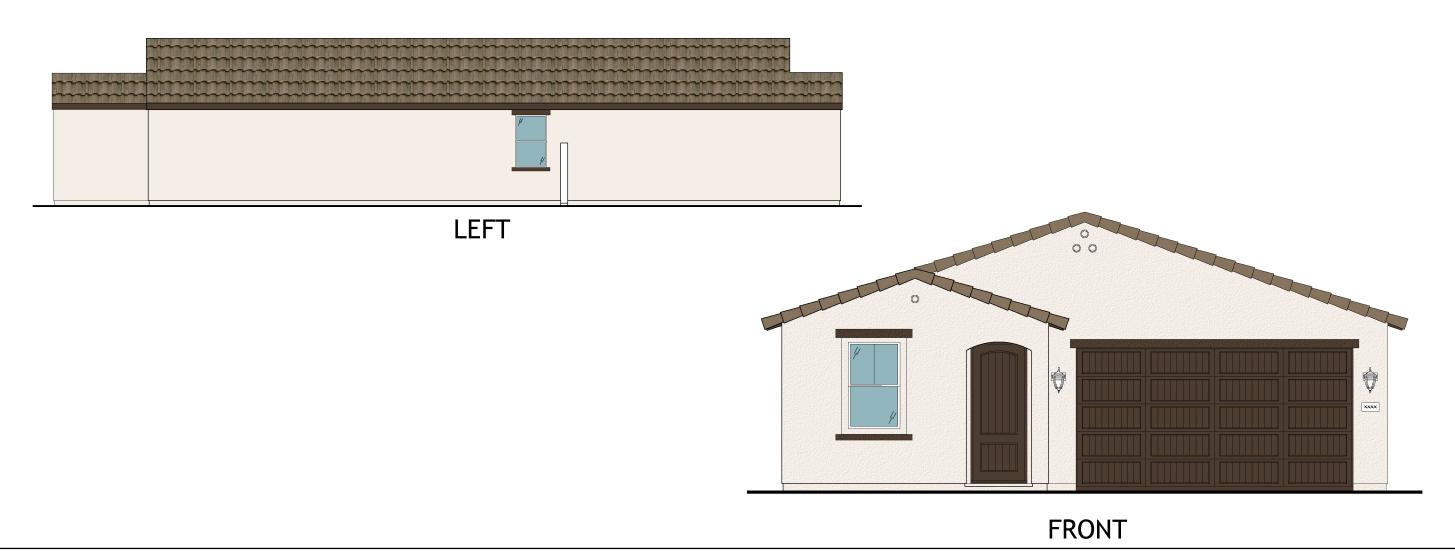




Plan 3520 - SPANISH - L1

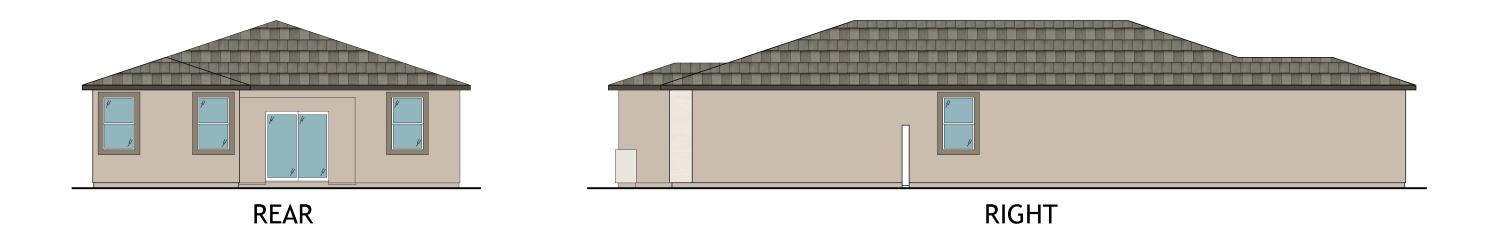

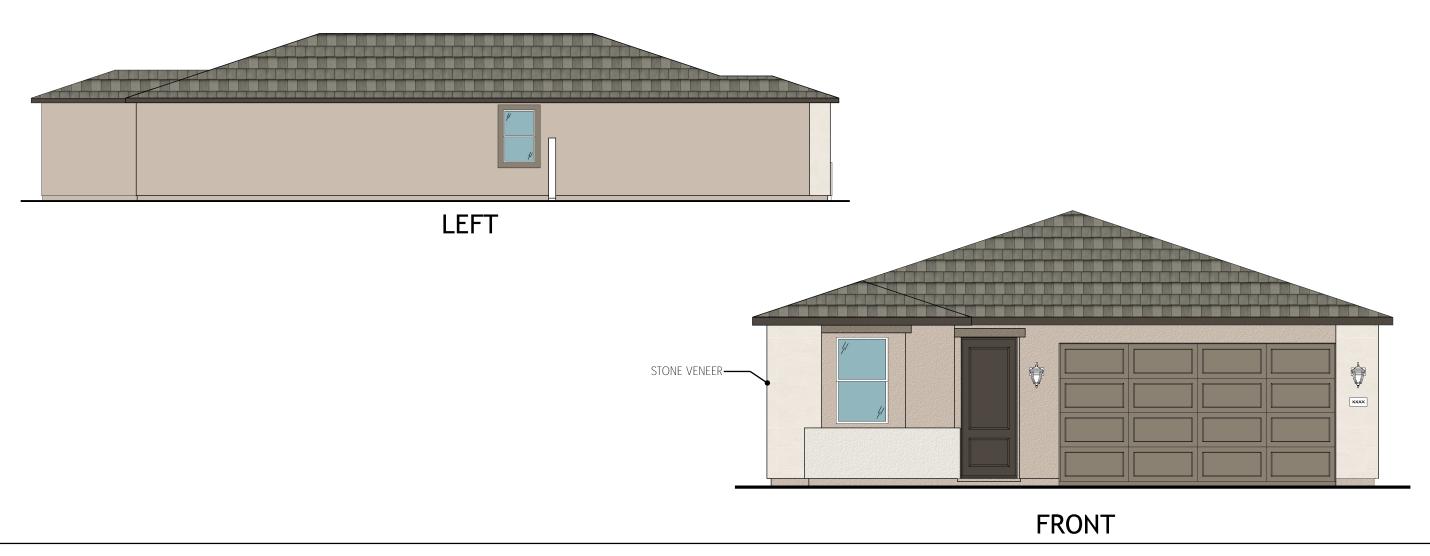




Plan 3520 - MODERN DESERT - T1

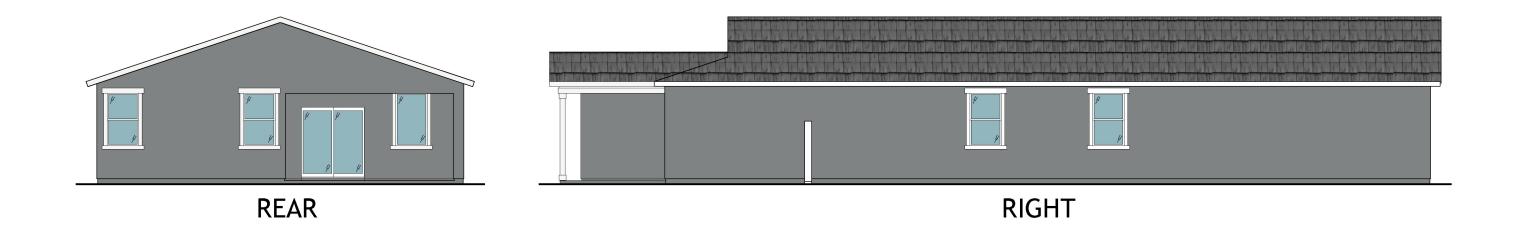






Plan 3530 - FARMHOUSE - J3

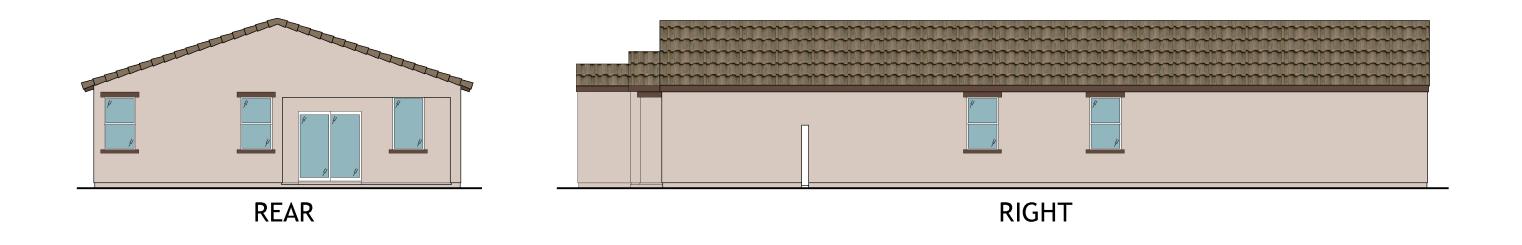


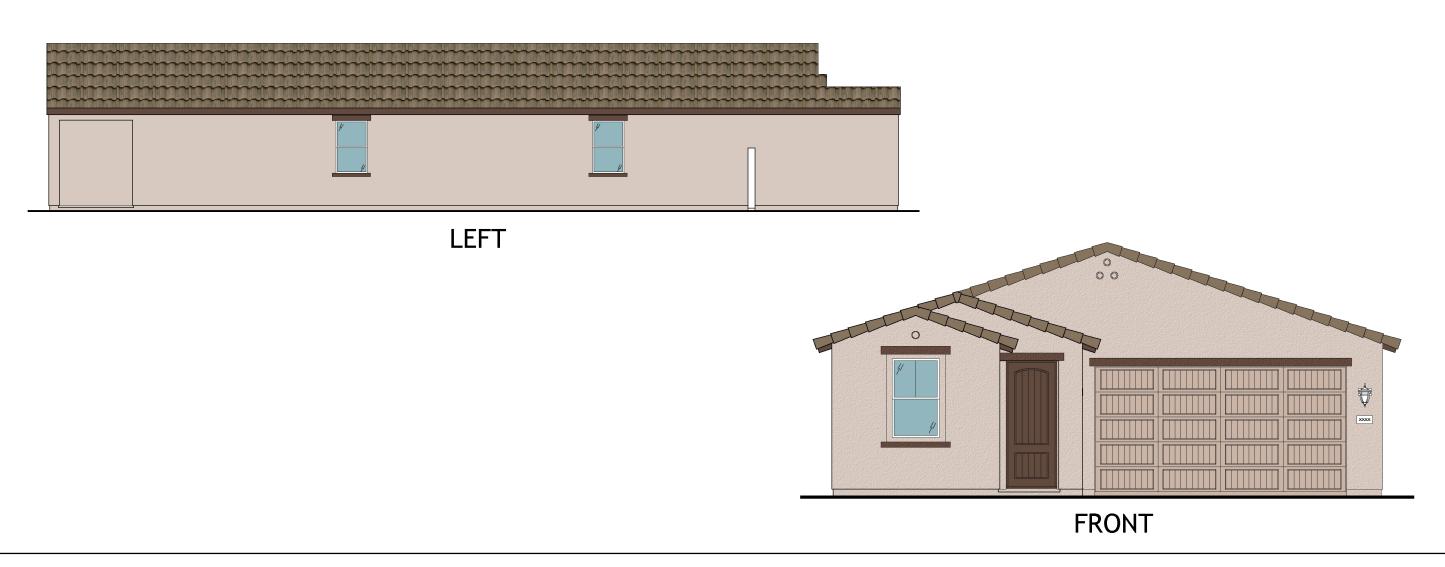




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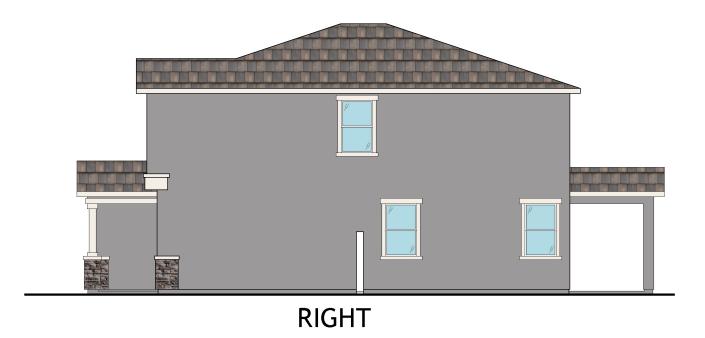





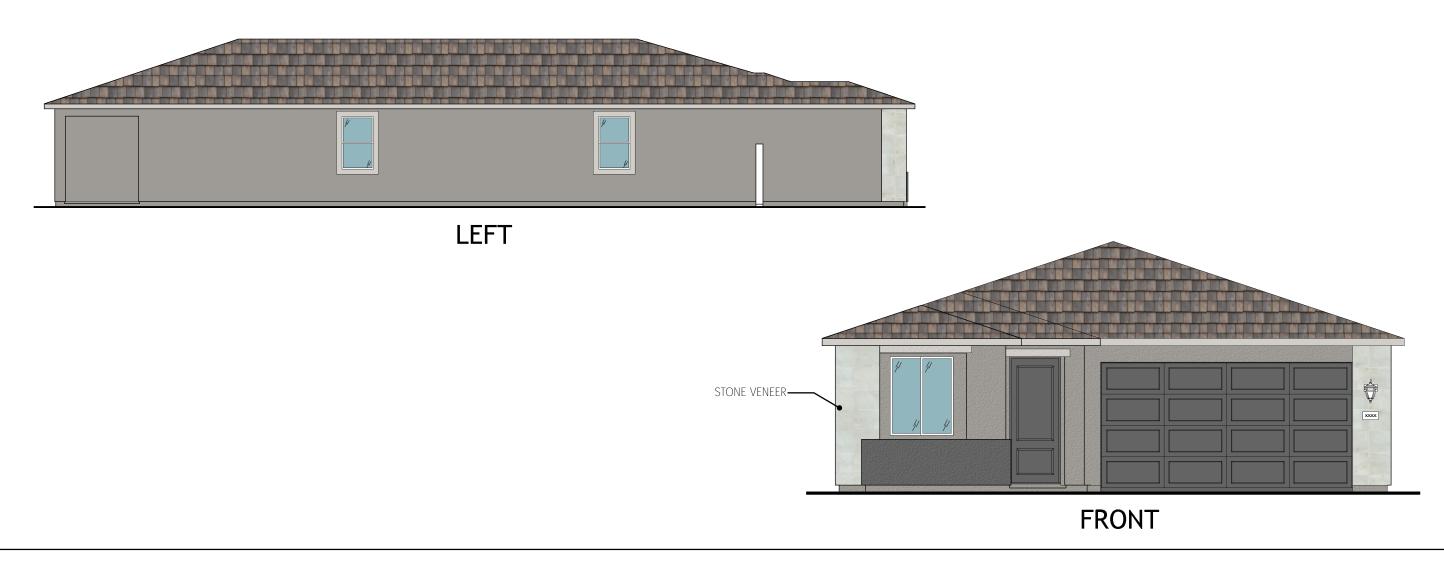


Plan 3530 - MODERN DESERT - T3



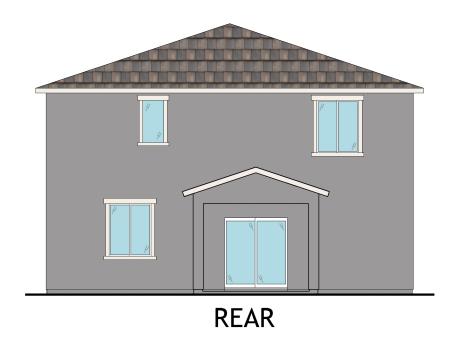

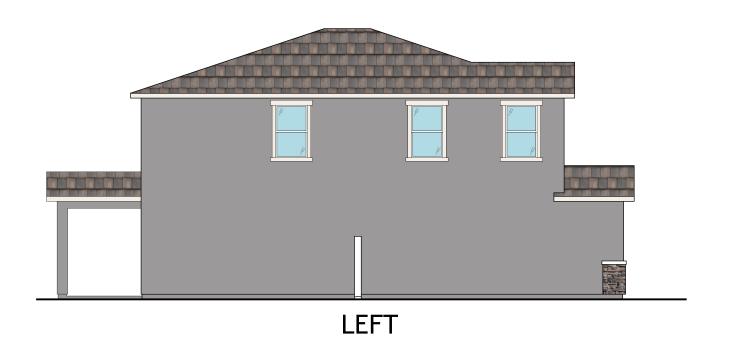


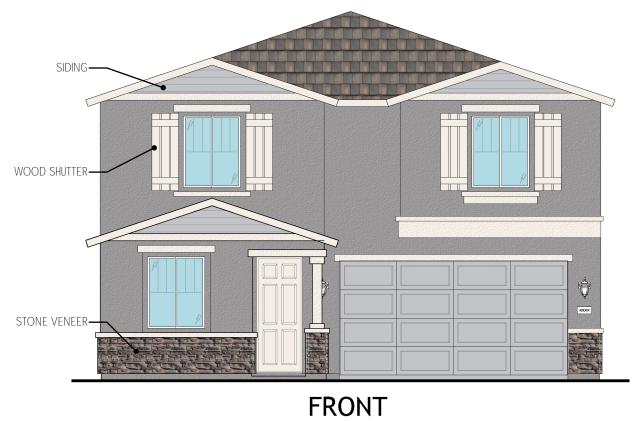






Plan 3540 - CRAFTSMAN - SCHEME D1

Hearing Date: April 16, 2025

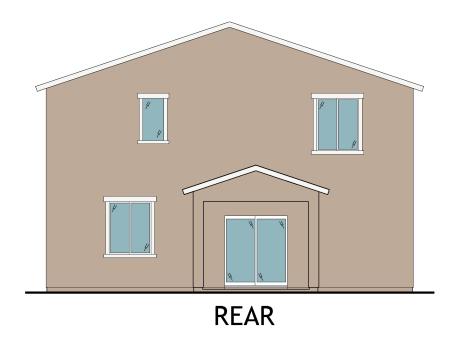

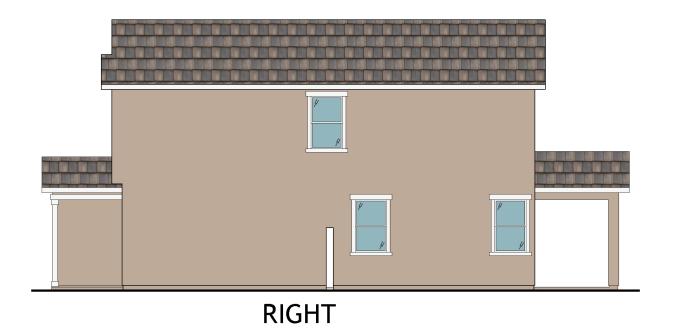


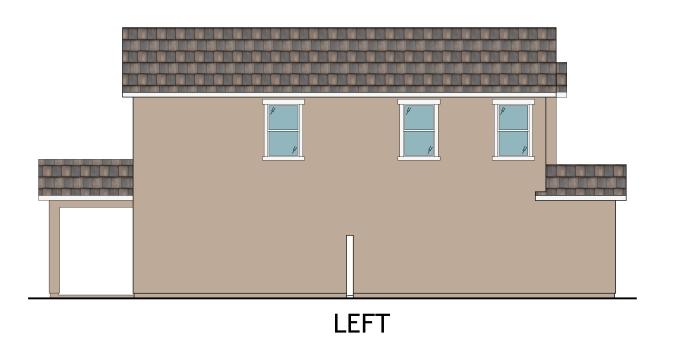


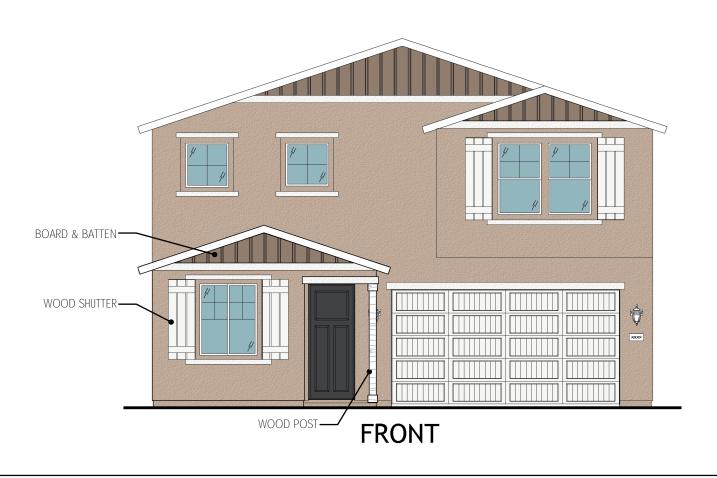





Plan 3540 - FARMHOUSE - SCHEME J1

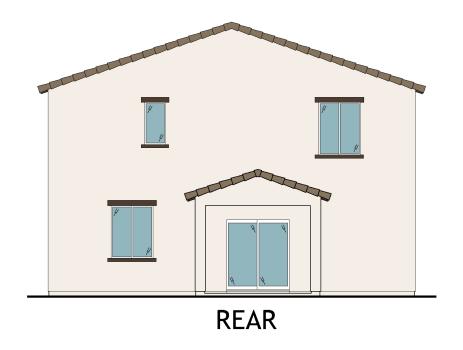

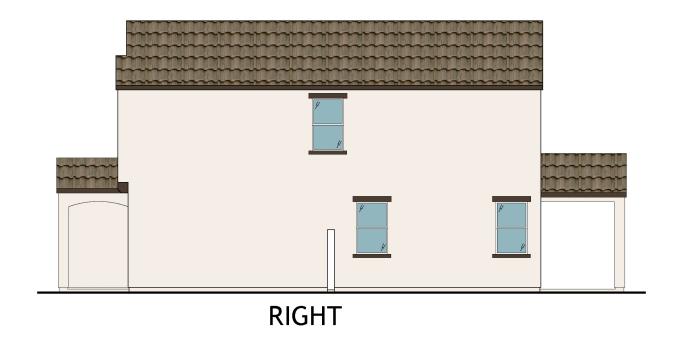


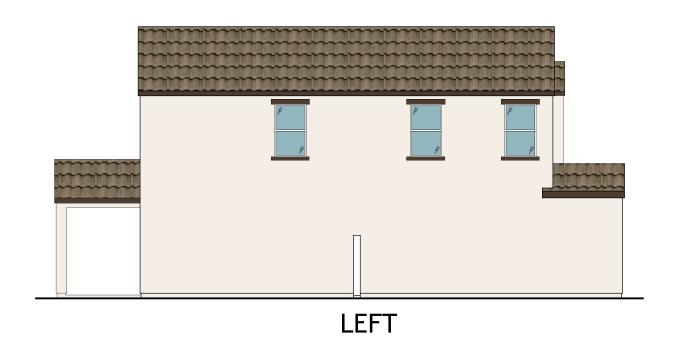


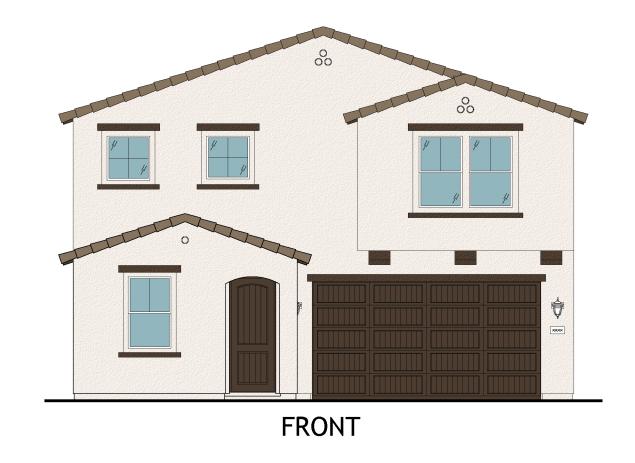




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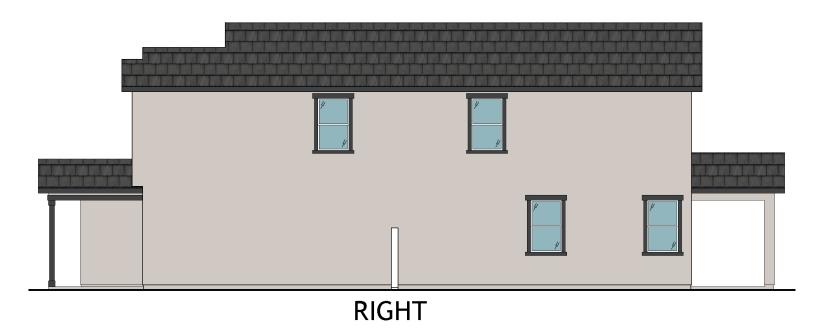


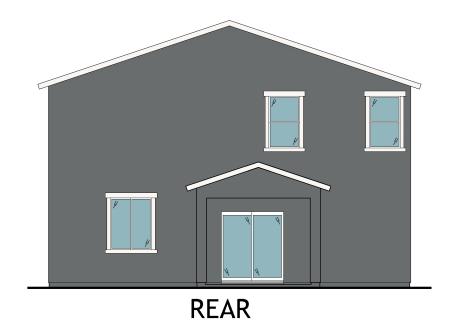


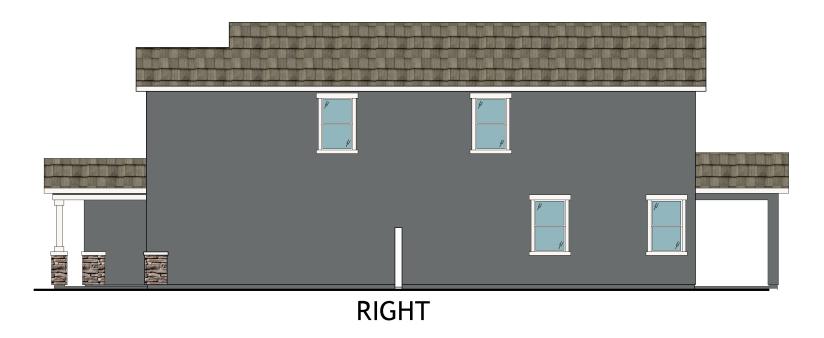






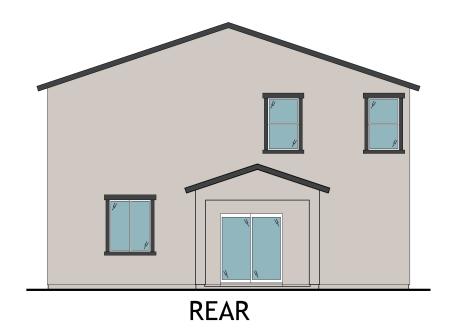


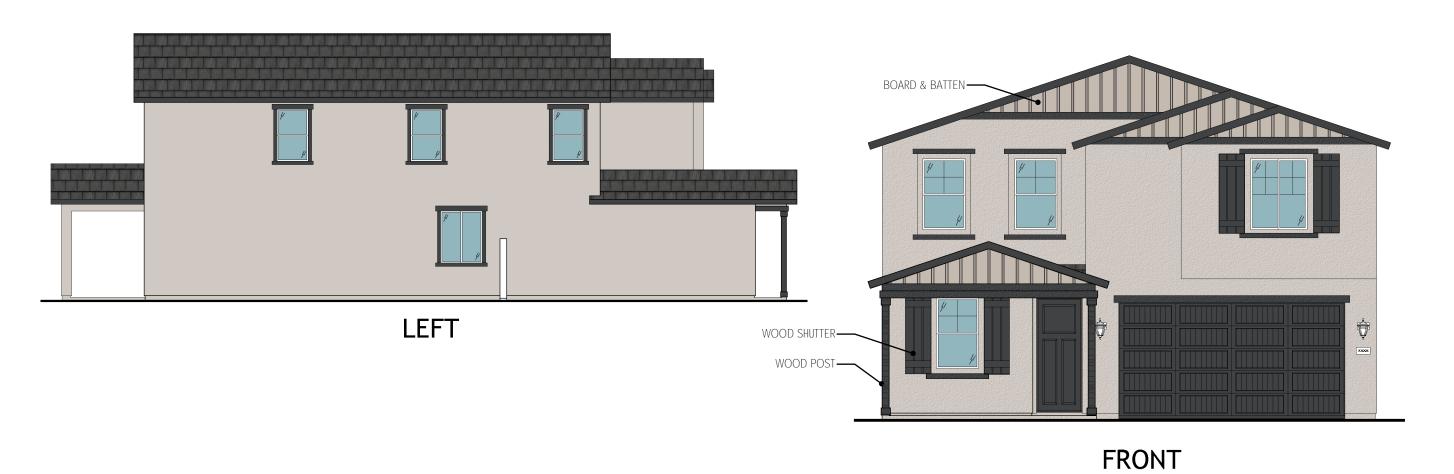




Plan 3550 - FARMHOUSE - SCHEME J2

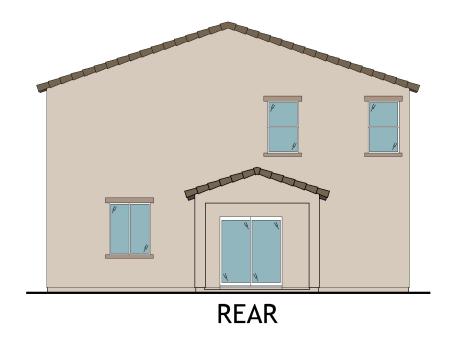

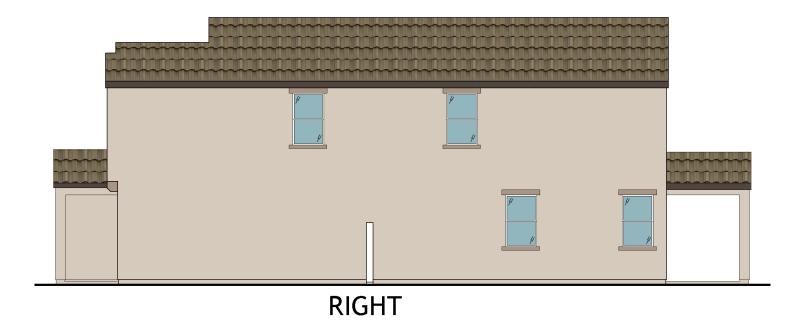

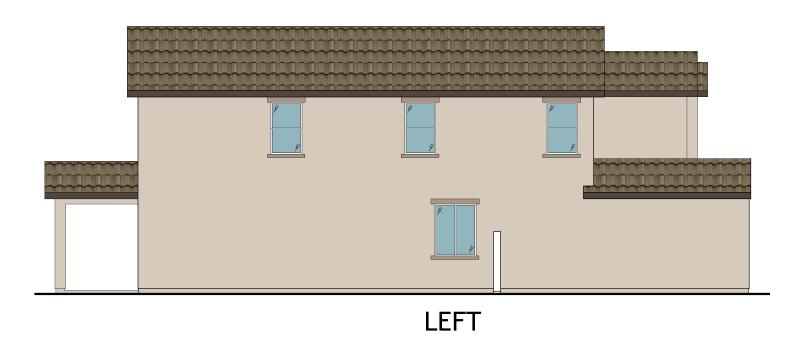






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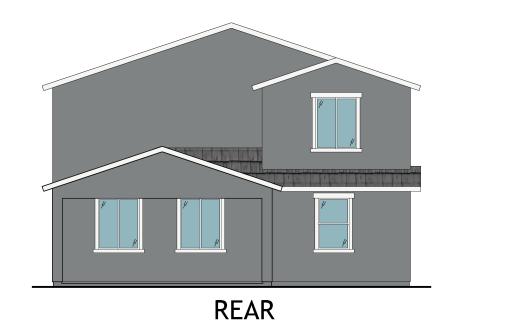
Plan 3550 - SPANISH - SCHEME L2







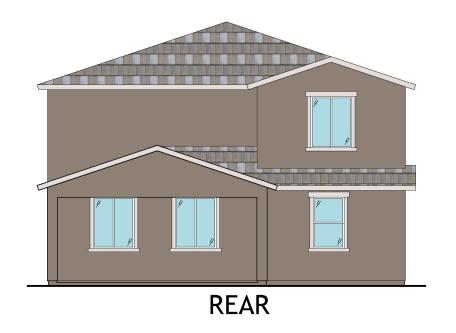

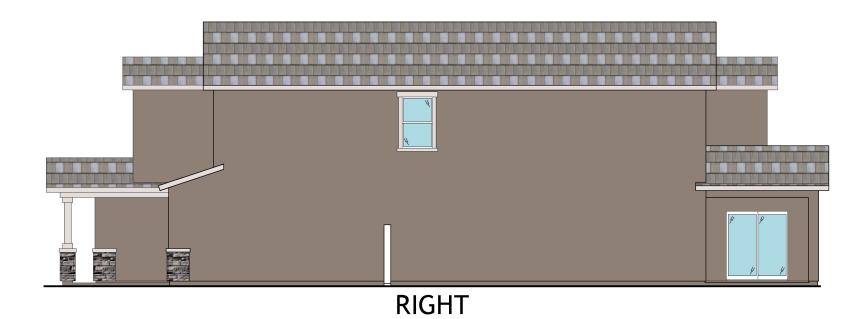

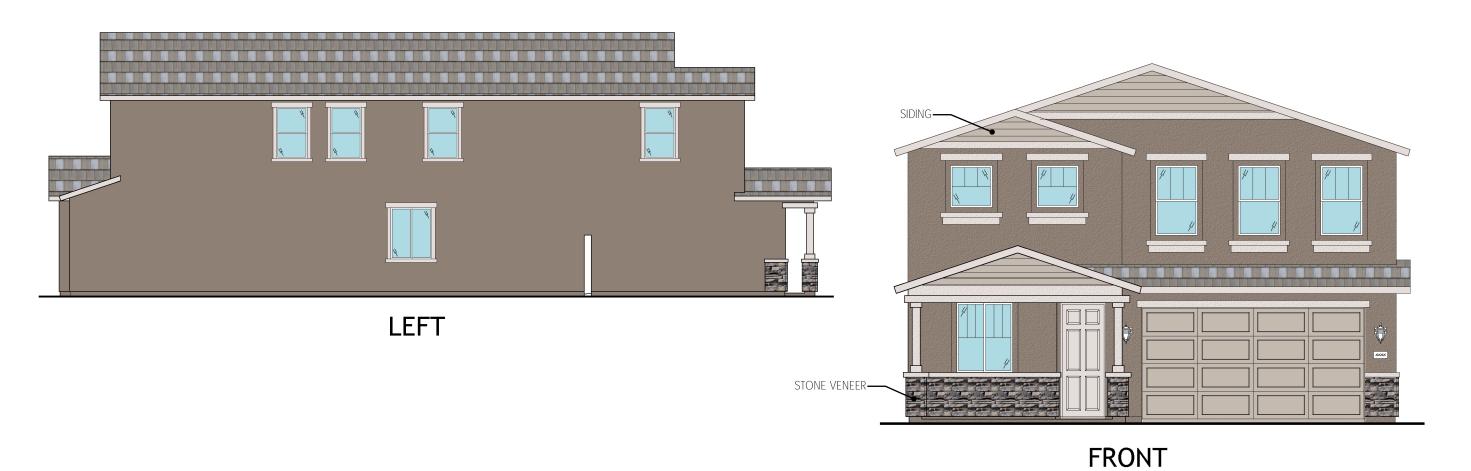


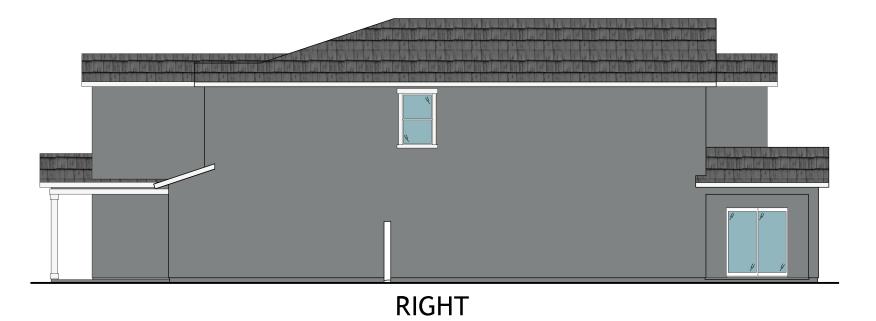


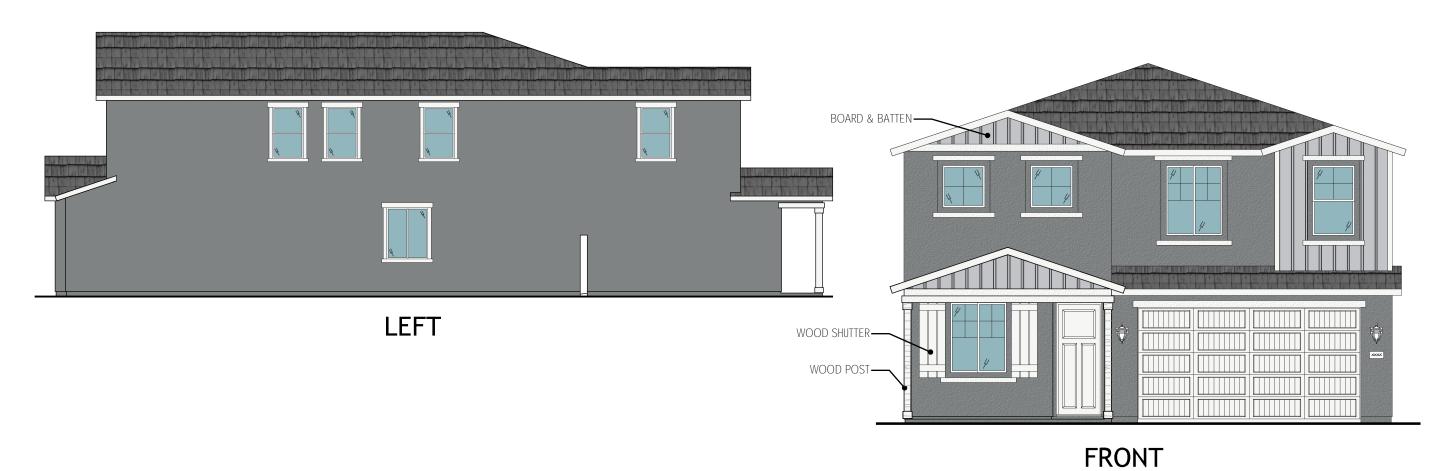





Plan 3560 - FARMHOUSE - SCHEME J3

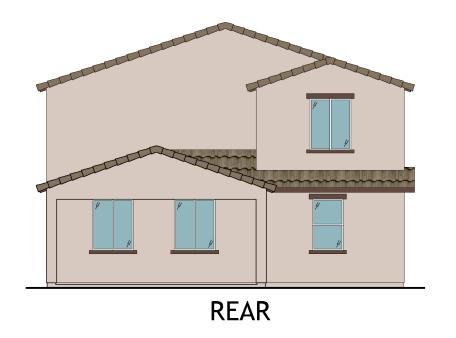

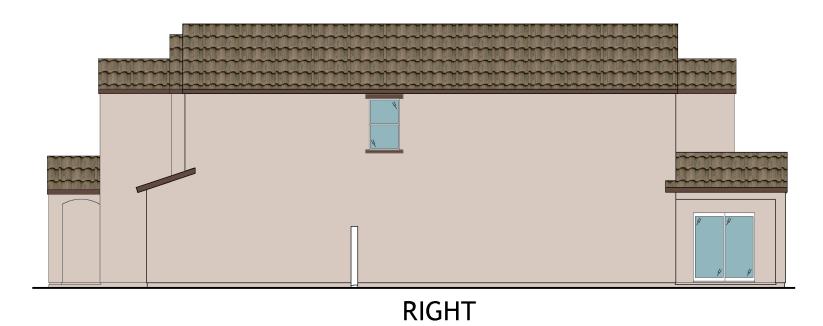


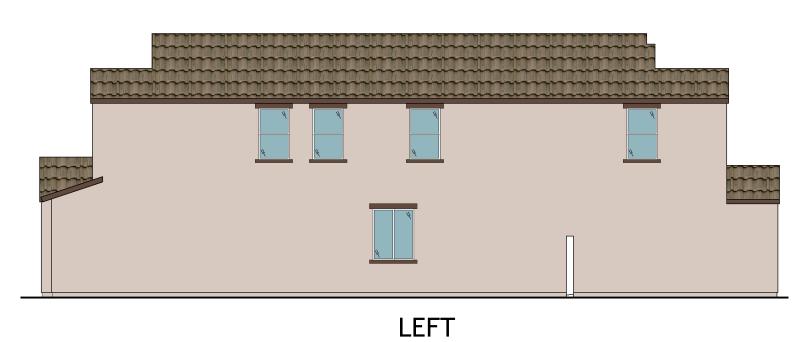


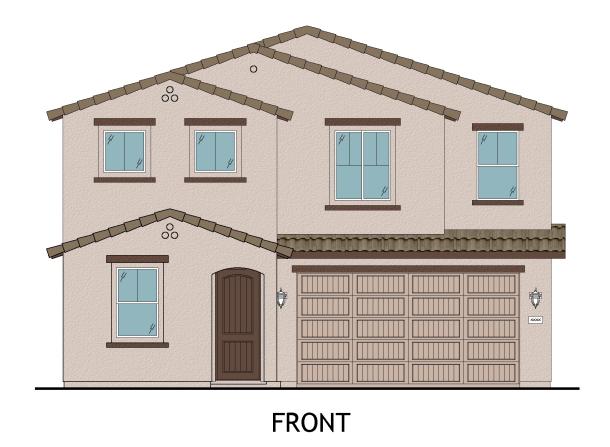



Plan 3560 - SPANISH - SCHEME L3

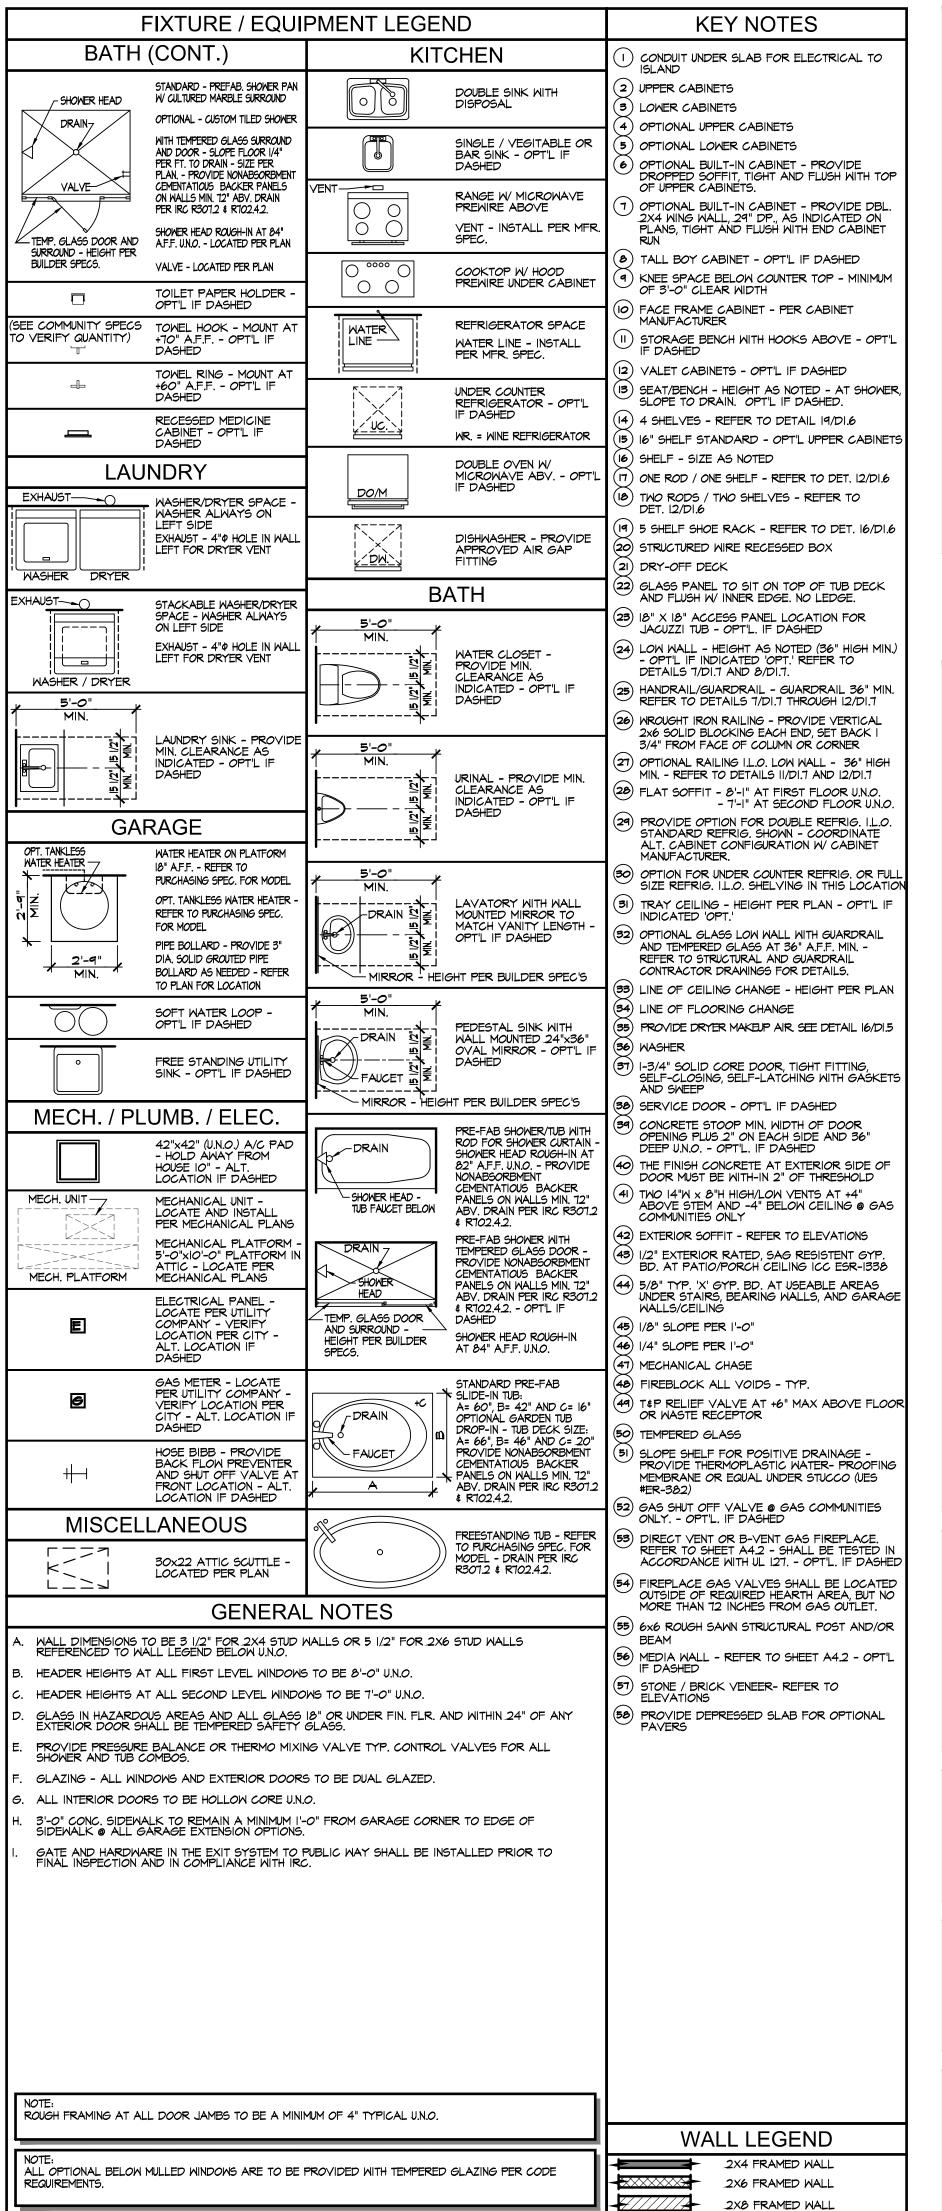

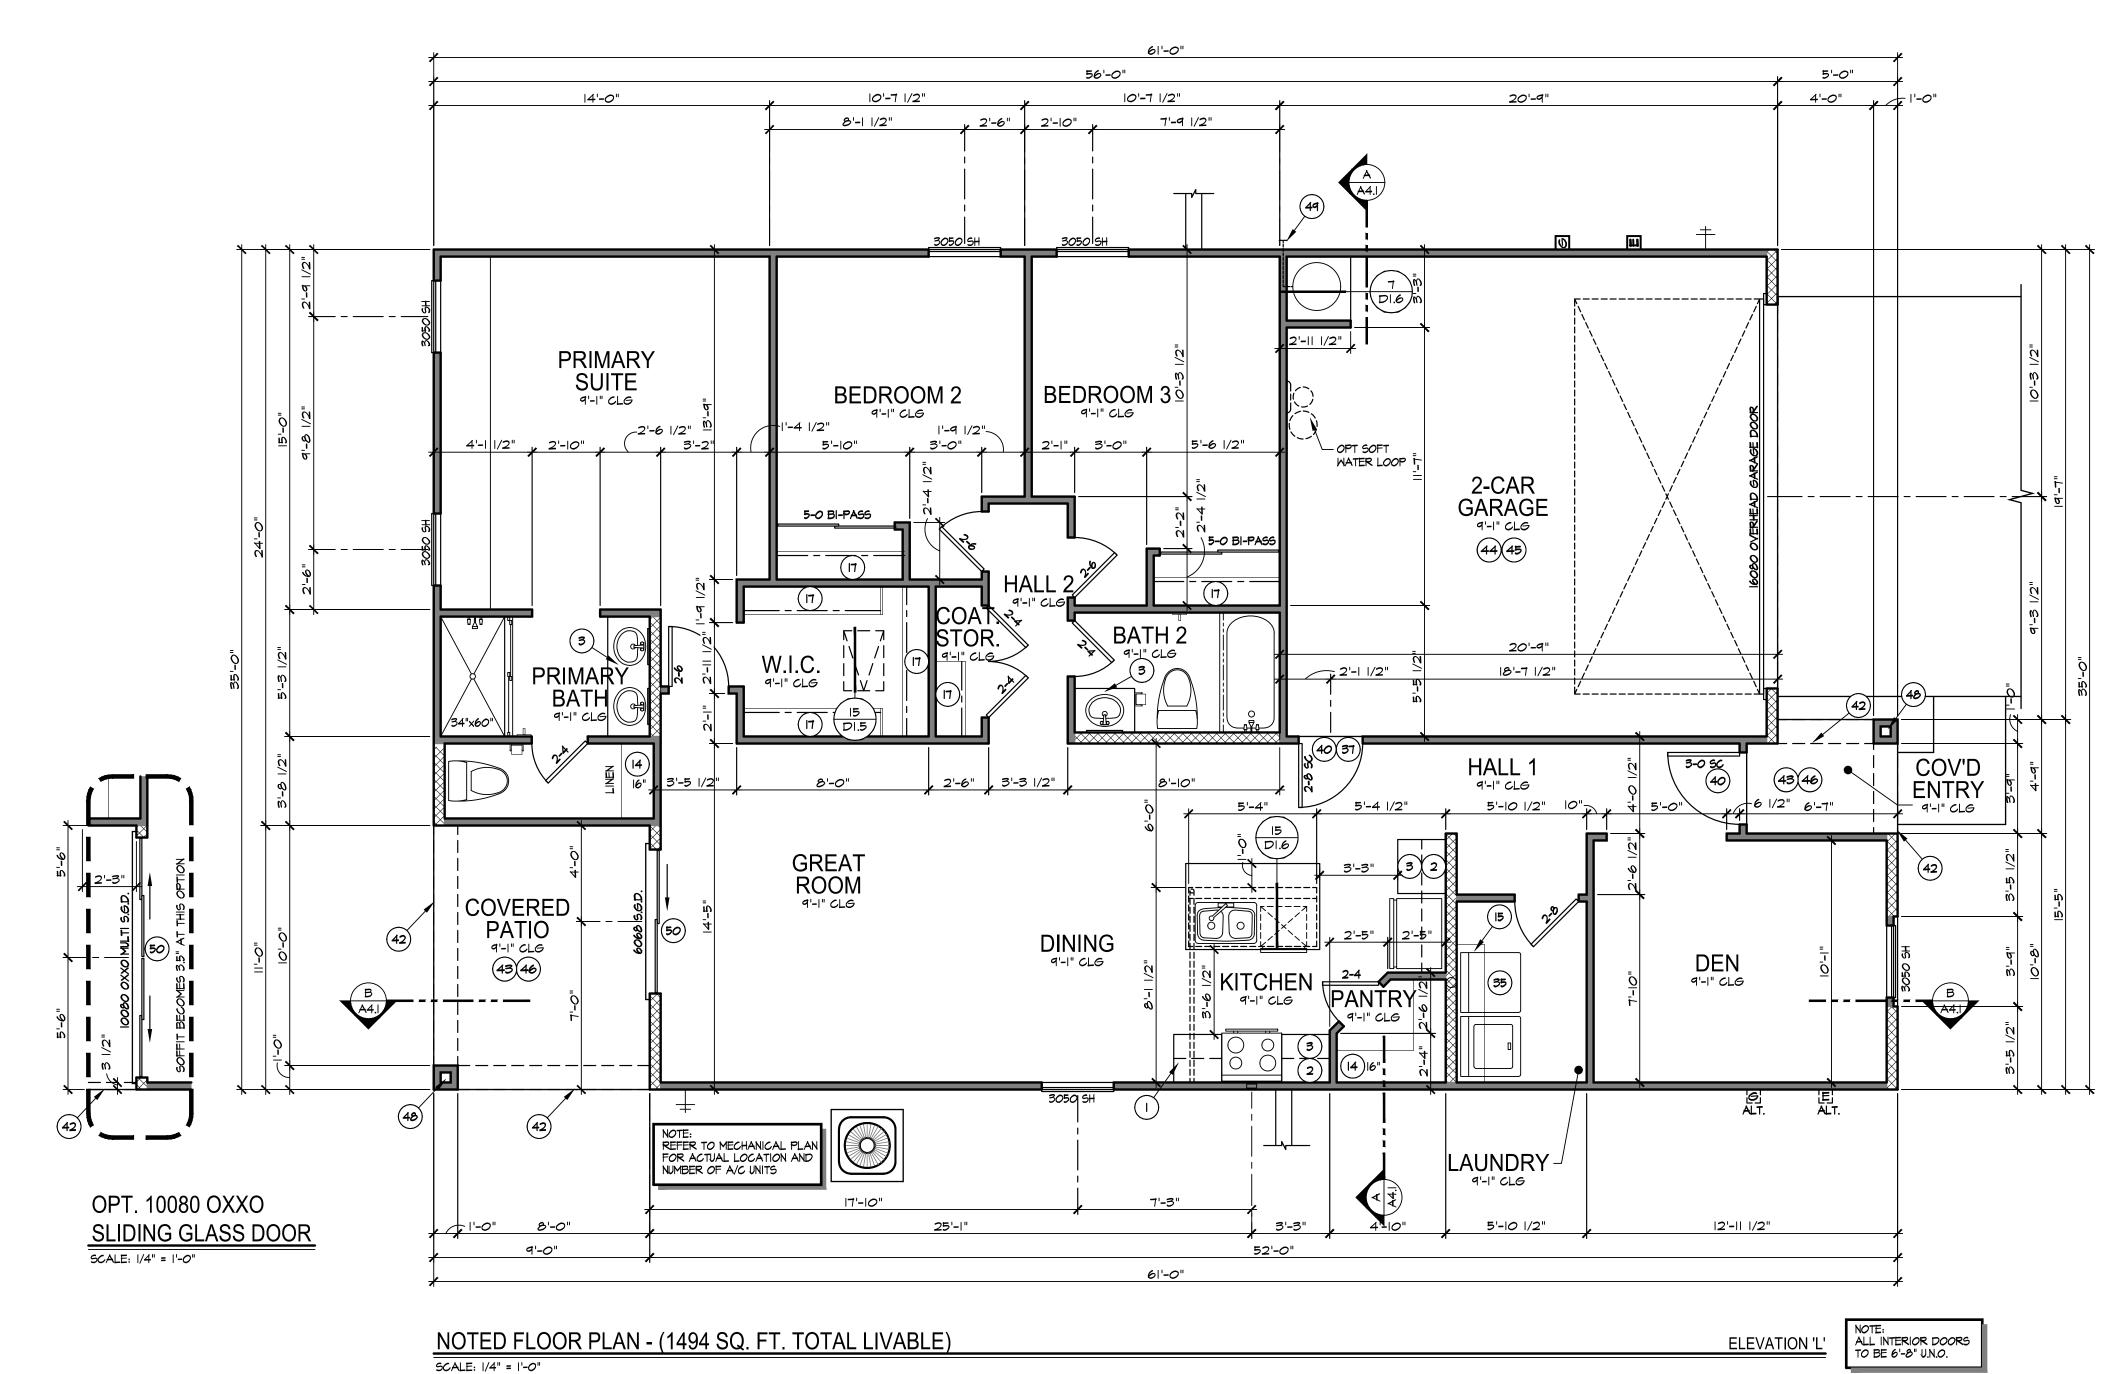

CITY OF PHOENIX

MAR 1 3 2025

Planning & Development Department

PHO-1-25--Z-12-22-7

April 16, 2025

SUBDIVISION

A **D** Z A N \geq

DRAWN BY: Outhouse DATE: JAN. 1, 2025

> PLAN# 3510

SHEET No.

- ONDUIT UNDER SLAB FOR ELECTRICAL TO ISLAND
- (2) UPPER CABINETS
- (3) LOWER CABINETS (4) OPTIONAL UPPER CABINETS
- (5) OPTIONAL LOWER CABINETS
- 6 OPTIONAL BUILT-IN CABINET PROVIDE DROPPED SOFFIT, TIGHT AND FLUSH WITH TOP OF UPPER CABINETS.
- 7 OPTIONAL BUILT-IN CABINET PROVIDE DBL. 2X4 WING WALL, 29" DP., AS INDICATED ON PLANS, TIGHT AND FLUSH WITH END CABINET
- (8) TALL BOY CABINET OPT'L IF DASHED
- 9 KNEE SPACE BELOW COUNTER TOP MINIMUM OF 3'-O" CLEAR WIDTH
- FACE FRAME CABINET PER CABINET MANUFACTURER
- II) STORAGE BENCH WITH HOOKS ABOVE OPT'L (12) VALET CABINETS - OPT'L IF DASHED
- SEAT/BENCH HEIGHT AS NOTED AT SHOWER, SLOPE TO DRAIN. OPT'L IF DASHED.
- (14) 4 SHELVES REFER TO DETAIL 19/DI.6 (15) 16" SHELF STANDARD - OPT'L UPPER CABINETS
- (6) SHELF SIZE AS NOTED (17) ONE ROD / ONE SHELF - REFER TO DET. 12/D1.6
- TWO RODS / TWO SHELVES REFER TO DET. 12/D1.6 (19) 5 SHELF SHOE RACK - REFER TO DET. 16/D1.6 (20) STRUCTURED WIRE RECESSED BOX
- (21) DRY-OFF DECK (22) GLASS PANEL TO SIT ON TOP OF TUB DECK AND FLUSH W/ INNER EDGE. NO LEDGE.
- 23) 18" X 18" ACCESS PANEL LOCATION FOR JACUZZI TUB OPT'L. IF DASHED
- 24) LOW WALL HEIGHT AS NOTED (36" HIGH MIN.) OPT'L IF INDICATED 'OPT.' REFER TO DETAILS 7/DI.7 AND 8/DI.7.
- HANDRAIL/GUARDRAIL GUARDRAIL 36" MIN. REFER TO DETAILS 1/DI.1 THROUGH 12/DI.1 (26) WROUGHT IRON RAILING - PROVIDE VERTICAL
- 2x6 SOLID BLOCKING EACH END, SET BACK I 3/4" FROM FACE OF COLUMN OR CORNER OPTIONAL RAILING I.L.O. LOW WALL - 36" HIGH MIN. - REFER TO DETAILS II/DI.7 AND 12/DI.7
- (28) FLAT SOFFIT 8'-1" AT FIRST FLOOR UNO. - 7'-1" AT SECOND FLOOR U.N.O.
- 29 PROVIDE OPTION FOR DOUBLE REFRIG. I.L.O. STANDARD REFRIG. SHOWN COORDINATE ALT. CABINET CONFIGURATION W/ CABINET MANUFACTURER.
- OPTION FOR UNDER COUNTER REFRIG. OR FULL SIZE REFRIG. I.L.O. SHELVING IN THIS LOCATION (31) TRAY CEILING - HEIGHT PER PLAN - OPT'L IF
- OPTIONAL GLASS LOW WALL WITH GUARDRAIL AND TEMPERED GLASS AT 36" A.F.F. MIN. -
- REFER TO STRUCTURAL AND GUARDRAIL CONTRACTOR DRAWINGS FOR DETAILS. (33) LINE OF CEILING CHANGE - HEIGHT PER PLAN
- (34) LINE OF FLOORING CHANGE (35) PROVIDE DRYER MAKEUP AIR SEE DETAIL 16/DI.5
- (36) WASHER (37) I-3/4" SOLID CORE DOOR, TIGHT FITTING, SELF-CLOSING, SELF-LATCHING WITH GASKETS AND SWEEP
- (38) SERVICE DOOR OPT'L IF DASHED
- OPENING PLUS 2" ON EACH SIDE AND 36" DEEP U.N.O. OPT'L. IF DASHED
- THE FINISH CONCRETE AT EXTERIOR SIDE OF DOOR MUST BE WITH-IN 2" OF THRESHOLD
- (4) TWO 14"W x 8"H HIGH/LOW VENTS AT +4" ABOVE STEM AND -4" BELOW CEILING @ GAS COMMUNITIES ONLY (42) EXTERIOR SOFFIT - REFER TO ELEVATIONS
- 43) 1/2" EXTERIOR RATED, SAG RESISTENT GYP. BD. AT PATIO/PORCH CEILING ICC ESR-1338 44) 5/8" TYP. 'X' GYP. BD. AT USEABLE AREAS UNDER STAIRS, BEARING WALLS, AND GARAGE WALLS/CEILING
- (45) 1/8" SLOPE PER 1'-0"
- (46) 1/4" SLOPE PER 1'-0" (47) MECHANICAL CHASE
- (48) FIREBLOCK ALL VOIDS TYP.
- T&P RELIEF VALVE AT +6" MAX ABOVE FLOOR OR WASTE RECEPTOR
- (50) TEMPERED GLASS
- 51) SLOPE SHELF FOR POSITIVE DRAINAGE -PROVIDE THERMOPLASTIC WATER- PROOFING MEMBRANE OR EQUAL UNDER STUCCO (UES #ER-382)
- 52) GAS SHUT OFF VALVE @ GAS COMMUNITIES ONLY. OPT'L. IF DASHED
- DIRECT VENT OR B-VENT GAS FIREPLACE.
 REFER TO SHEET A4.2 SHALL BE TESTED IN
 ACCORDANCE WITH UL 127. OPT'L. IF DASHED
- (54) FIREPLACE GAS VALVES SHALL BE LOCATED OUTSIDE OF REQUIRED HEARTH AREA, BUT NO MORE THAN 12 INCHES FROM GAS OUTLET. (55) 6x6 ROUGH SAWN STRUCTURAL POST AND/OR
- 56 MEDIA WALL REFER TO SHEET A4.2 OPT'L IF DASHED
- 57) STONE / BRICK VENEER- REFER TO ELEVATIONS
- PROVIDE DEPRESSED SLAB FOR OPTIONAL PAVERS

SUBDIVISION



M ART Δ 'ATION MAIN

DRAWN BY: Outhouse DATE: JAN. 1, 2025

3510



SHEET No.

WALL LEGEND 2X4 FRAMED WALL 2X6 FRAMED WALL 2X8 FRAMED WALL

ONDUIT UNDER SLAB FOR ELECTRICAL TO ISLAND

(2) UPPER CABINETS

(3) LOWER CABINETS (4) OPTIONAL UPPER CABINETS

(5) OPTIONAL LOWER CABINETS

6 OPTIONAL BUILT-IN CABINET - PROVIDE DROPPED SOFFIT, TIGHT AND FLUSH WITH TOP OF UPPER CABINETS. 7 OPTIONAL BUILT-IN CABINET - PROVIDE DBL. 2X4 WING WALL, 29" DP., AS INDICATED ON PLANS, TIGHT AND FLUSH WITH END CABINET

(8) TALL BOY CABINET - OPT'L IF DASHED

9 KNEE SPACE BELOW COUNTER TOP - MINIMUM OF 3'-O" CLEAR WIDTH FACE FRAME CABINET - PER CABINET MANUFACTURER

II) STORAGE BENCH WITH HOOKS ABOVE - OPT'L

(12) VALET CABINETS - OPT'L IF DASHED SEAT/BENCH - HEIGHT AS NOTED - AT SHOWER, SLOPE TO DRAIN. OPT'L IF DASHED.

(14) 4 SHELVES - REFER TO DETAIL 19/DI.6 (15) 16" SHELF STANDARD - OPT'L UPPER CABINETS (6) SHELF - SIZE AS NOTED

 (Π) ONE ROD / ONE SHELF - REFER TO DET. 12/D1.6 TWO RODS / TWO SHELVES - REFER TO DET. 12/D1.6

(19) 5 SHELF SHOE RACK - REFER TO DET. 16/D1.6 (20) STRUCTURED WIRE RECESSED BOX (21) DRY-OFF DECK

(22) GLASS PANEL TO SIT ON TOP OF TUB DECK AND FLUSH W/ INNER EDGE. NO LEDGE.

23) 18" X 18" ACCESS PANEL LOCATION FOR JACUZZI TUB - OPT'L. IF DASHED 24) LOW WALL - HEIGHT AS NOTED (36" HIGH MIN.) - OPT'L IF INDICATED 'OPT.' REFER TO DETAILS 7/DI.7 AND 8/DI.7.

HANDRAIL/GUARDRAIL - GUARDRAIL 36" MIN. REFER TO DETAILS 1/DI.1 THROUGH 12/DI.1

(26) WROUGHT IRON RAILING - PROVIDE VERTICAL 2x6 SOLID BLOCKING EACH END, SET BACK I 3/4" FROM FACE OF COLUMN OR CORNER OPTIONAL RAILING I.L.O. LOW WALL - 36" HIGH MIN. - REFER TO DETAILS II/DI.7 AND 12/DI.7

(28) FLAT SOFFIT - 8'-1" AT FIRST FLOOR UNO. - 7'-1" AT SECOND FLOOR U.N.O.

29 PROVIDE OPTION FOR DOUBLE REFRIG. I.L.O. STANDARD REFRIG. SHOWN - COORDINATE ALT. CABINET CONFIGURATION W/ CABINET MANUFACTURER.

OPTION FOR UNDER COUNTER REFRIG. OR FULL SIZE REFRIG. I.L.O. SHELVING IN THIS LOCATION (31) TRAY CEILING - HEIGHT PER PLAN - OPT'L IF

OPTIONAL GLASS LOW WALL WITH GUARDRAIL AND TEMPERED GLASS AT 36" A.F.F. MIN. -REFER TO STRUCTURAL AND GUARDRAIL CONTRACTOR DRAWINGS FOR DETAILS.

(33) LINE OF CEILING CHANGE - HEIGHT PER PLAN (34) LINE OF FLOORING CHANGE

(35) PROVIDE DRYER MAKEUP AIR SEE DETAIL 16/DI.5 (36) WASHER

(37) I-3/4" SOLID CORE DOOR, TIGHT FITTING, SELF-CLOSING, SELF-LATCHING WITH GASKETS AND SWEEP

(38) SERVICE DOOR - OPT'L IF DASHED OPENING PLUS 2" ON EACH SIDE AND 36" DEEP U.N.O. - OPT'L. IF DASHED

THE FINISH CONCRETE AT EXTERIOR SIDE OF DOOR MUST BE WITH-IN 2" OF THRESHOLD (4) TWO 14"M × 8"H HIGH/LOW VENTS AT +4" ABOVE STEM AND -4" BELOW CEILING @ GAS COMMUNITIES ONLY

(42) EXTERIOR SOFFIT - REFER TO ELEVATIONS

43) 1/2" EXTERIOR RATED, SAG RESISTENT GYP. BD. AT PATIO/PORCH CEILING ICC ESR-1338 44) 5/8" TYP. 'X' GYP. BD. AT USEABLE AREAS UNDER STAIRS, BEARING WALLS, AND GARAGE WALLS/CEILING

(45) 1/8" SLOPE PER 1'-0"

(46) 1/4" SLOPE PER 1'-0"

(47) MECHANICAL CHASE (48) FIREBLOCK ALL VOIDS - TYP.

T&P RELIEF VALVE AT +6" MAX ABOVE FLOOR OR WASTE RECEPTOR (50) TEMPERED GLASS

51) SLOPE SHELF FOR POSITIVE DRAINAGE -PROVIDE THERMOPLASTIC WATER- PROOFING MEMBER 342)

52) GAS SHUT OFF VALVE @ GAS COMMUNITIES ONLY. - OPT'L. IF DASHED

DIRECT VENT OR B-VENT GAS FIREPLACE.
REFER TO SHEET A4.2 - SHALL BE TESTED IN
ACCORDANCE WITH UL 127. - OPT'L. IF DASHED

(54) FIREPLACE GAS VALVES SHALL BE LOCATED OUTSIDE OF REQUIRED HEARTH AREA, BUT NO MORE THAN 12 INCHES FROM GAS OUTLET. (55) 6x6 ROUGH SAWN STRUCTURAL POST AND/OR

56 MEDIA WALL - REFER TO SHEET A4.2 - OPT'! IF DASHED

57) STONE / BRICK VENEER- REFER TO ELEVATIONS

PROVIDE DEPRESSED SLAB FOR OPTIONAL PAVERS

SUBDIVISION



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DRAWN BY: Outhouse DATE: JAN. 1, 2025


3510



SHEET No.

WALL LEGEND 2X4 FRAMED WALL 2X6 FRAMED WALL 2X8 FRAMED WALL

SCALE: 1/4" = 1'-0"

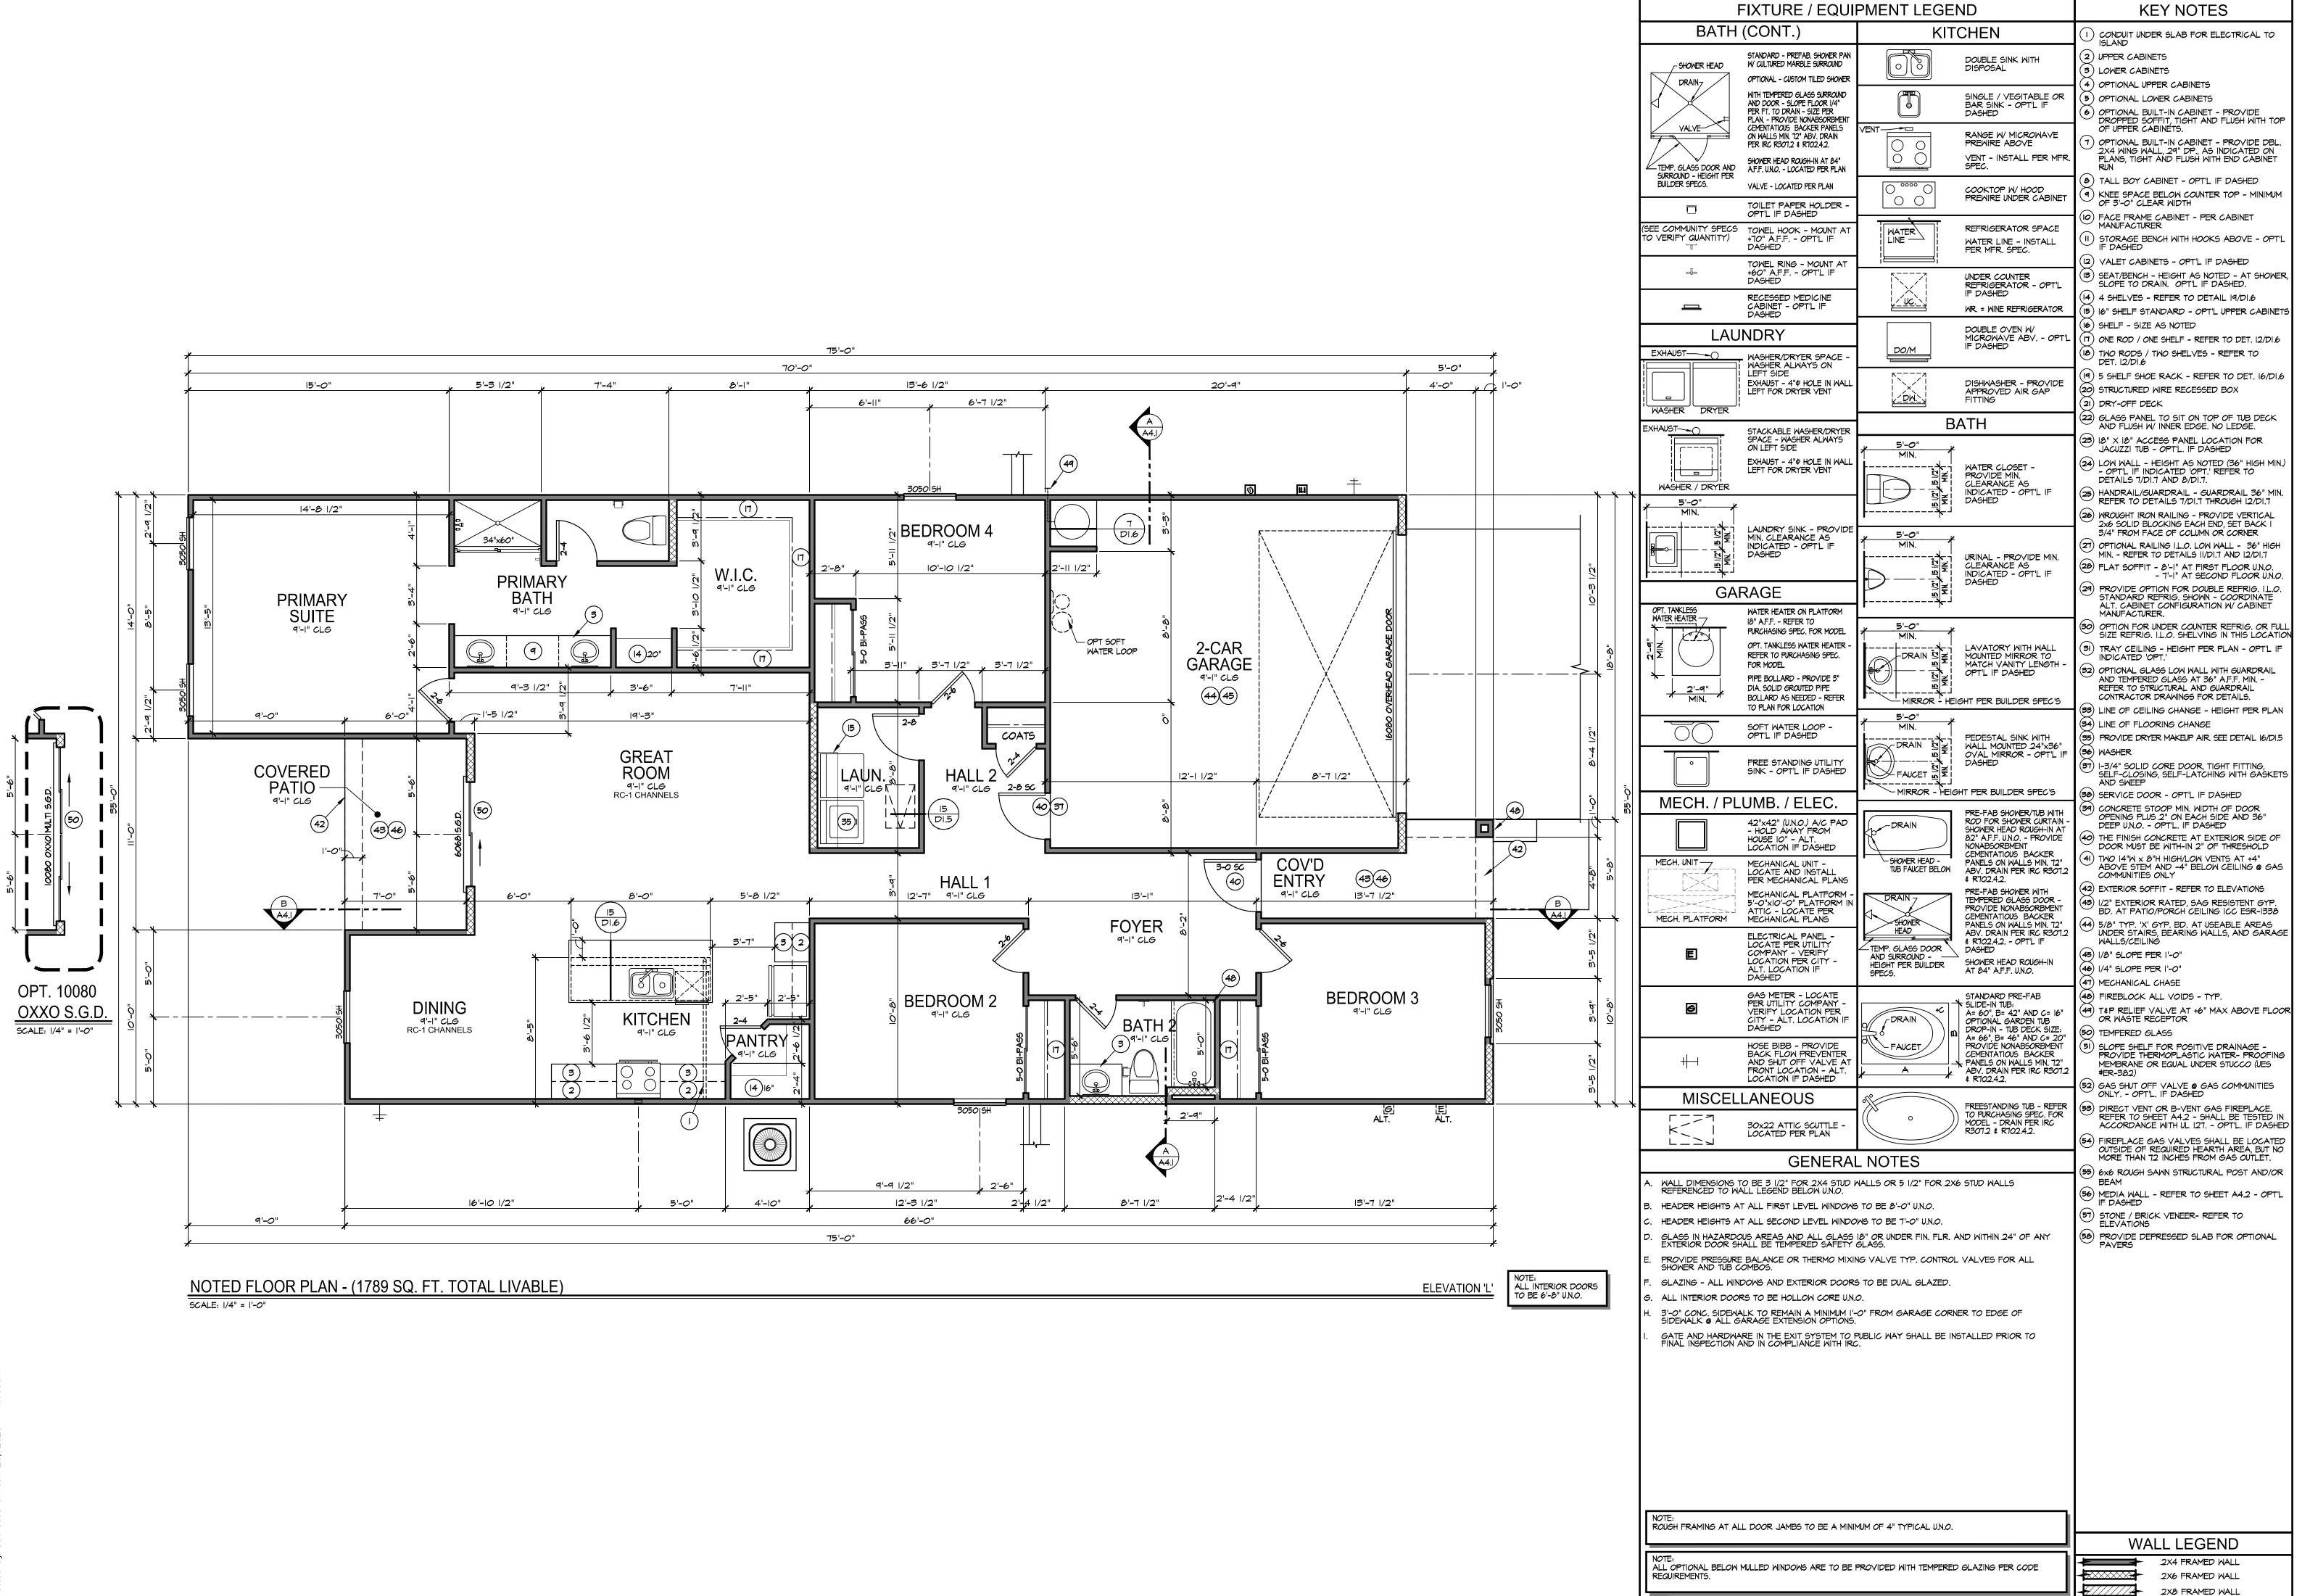

SOLARA 35' SERIES



MAIN LEVEL NOTED FLOOR PLAN

3520



A1.1

SHEET No.

PROVIDE OPTION FOR DOUBLE REFRIG. I.L.O. STANDARD REFRIG. SHOWN - COORDINATE ALT. CABINET CONFIGURATION W/ CABINET MANUFACTURER.

OPTION FOR UNDER COUNTER REFRIG. OR FULL SIZE REFRIG. I.L.O. SHELVING IN THIS LOCATION (31) TRAY CEILING - HEIGHT PER PLAN - OPT'L IF

(2) UPPER CABINETS (3) LOWER CABINETS

(4) OPTIONAL UPPER CABINETS (5) OPTIONAL LOWER CABINETS

6 OPTIONAL BUILT-IN CABINET - PROVIDE DROPPED SOFFIT, TIGHT AND FLUSH WITH TOP OF UPPER CABINETS.

7 OPTIONAL BUILT-IN CABINET - PROVIDE DBL. 2X4 WING WALL, 29" DP., AS INDICATED ON PLANS, TIGHT AND FLUSH WITH END CABINET

9 KNEE SPACE BELOW COUNTER TOP - MINIMUM OF 3'-O" CLEAR WIDTH

II) STORAGE BENCH WITH HOOKS ABOVE - OPT'L

SEAT/BENCH - HEIGHT AS NOTED - AT SHOWER, SLOPE TO DRAIN. OPT'L IF DASHED.

(8) TALL BOY CABINET - OPT'L IF DASHED

FACE FRAME CABINET - PER CABINET MANUFACTURER

(12) VALET CABINETS - OPT'L IF DASHED

(14) 4 SHELVES - REFER TO DETAIL 19/DI.6 $oxedsymbol{(15)}$ $oxedsymbol{(6)}$ 16" SHELF STANDARD - OPT'L UPPER CABINETS

OPTIONAL GLASS LOW WALL WITH GUARDRAIL AND TEMPERED GLASS AT 36" A.F.F. MIN. -REFER TO STRUCTURAL AND GUARDRAIL CONTRACTOR DRAWINGS FOR DETAILS.

(34) LINE OF FLOORING CHANGE (35) PROVIDE DRYER MAKEUP AIR SEE DETAIL 16/DI.5 (36) WASHER

(97) 1-3/4" SOLID CORE DOOR, TIGHT FITTING, SELF-CLOSING, SELF-LATCHING WITH GASKETS AND SWEEP (38) SERVICE DOOR - OPT'L IF DASHED

CONCRETE STOOP MIN. WIDTH OF DOOR OPENING PLUS 2" ON EACH SIDE AND 36" DEEP U.N.O. - OPT'L. IF DASHED THE FINISH CONCRETE AT EXTERIOR SIDE OF DOOR MUST BE WITH-IN 2" OF THRESHOLD

(4) TWO 14"M × 8"H HIGH/LOW VENTS AT +4" ABOVE STEM AND -4" BELOW CEILING @ GAS COMMUNITIES ONLY (42) EXTERIOR SOFFIT - REFER TO ELEVATIONS

43) 1/2" EXTERIOR RATED, SAG RESISTENT GYP. BD. AT PATIO/PORCH CEILING ICC ESR-1338 44) 5/8" TYP. 'X' GYP. BD. AT USEABLE AREAS UNDER STAIRS, BEARING WALLS, AND GARAGE WALLS/CEILING

(45) 1/8" SLOPE PER 1'-0" (46) 1/4" SLOPE PER 1'-0"

(47) MECHANICAL CHASE (48) FIREBLOCK ALL VOIDS - TYP. T&P RELIEF VALVE AT +6" MAX ABOVE FLOOR OR WASTE RECEPTOR

(50) TEMPERED GLASS 51) SLOPE SHELF FOR POSITIVE DRAINAGE -PROVIDE THERMOPLASTIC WATER- PROOFING MEMBER 342)

52) GAS SHUT OFF VALVE @ GAS COMMUNITIES ONLY. - OPT'L. IF DASHED

DIRECT VENT OR B-VENT GAS FIREPLACE.
REFER TO SHEET A4.2 - SHALL BE TESTED IN
ACCORDANCE WITH UL 127. - OPT'L. IF DASHED

FIREPLACE GAS VALVES SHALL BE LOCATED OUTSIDE OF REQUIRED HEARTH AREA, BUT NO MORE THAN 12 INCHES FROM GAS OUTLET. (55) 6x6 ROUGH SAWN STRUCTURAL POST AND/OR

56 MEDIA WALL - REFER TO SHEET A4.2 - OPT'! IF DASHED

57) STONE / BRICK VENEER- REFER TO ELEVATIONS PROVIDE DEPRESSED SLAB FOR OPTIONAL PAVERS DRAWN BY: Outhouse DATE: JAN. 1, 2025

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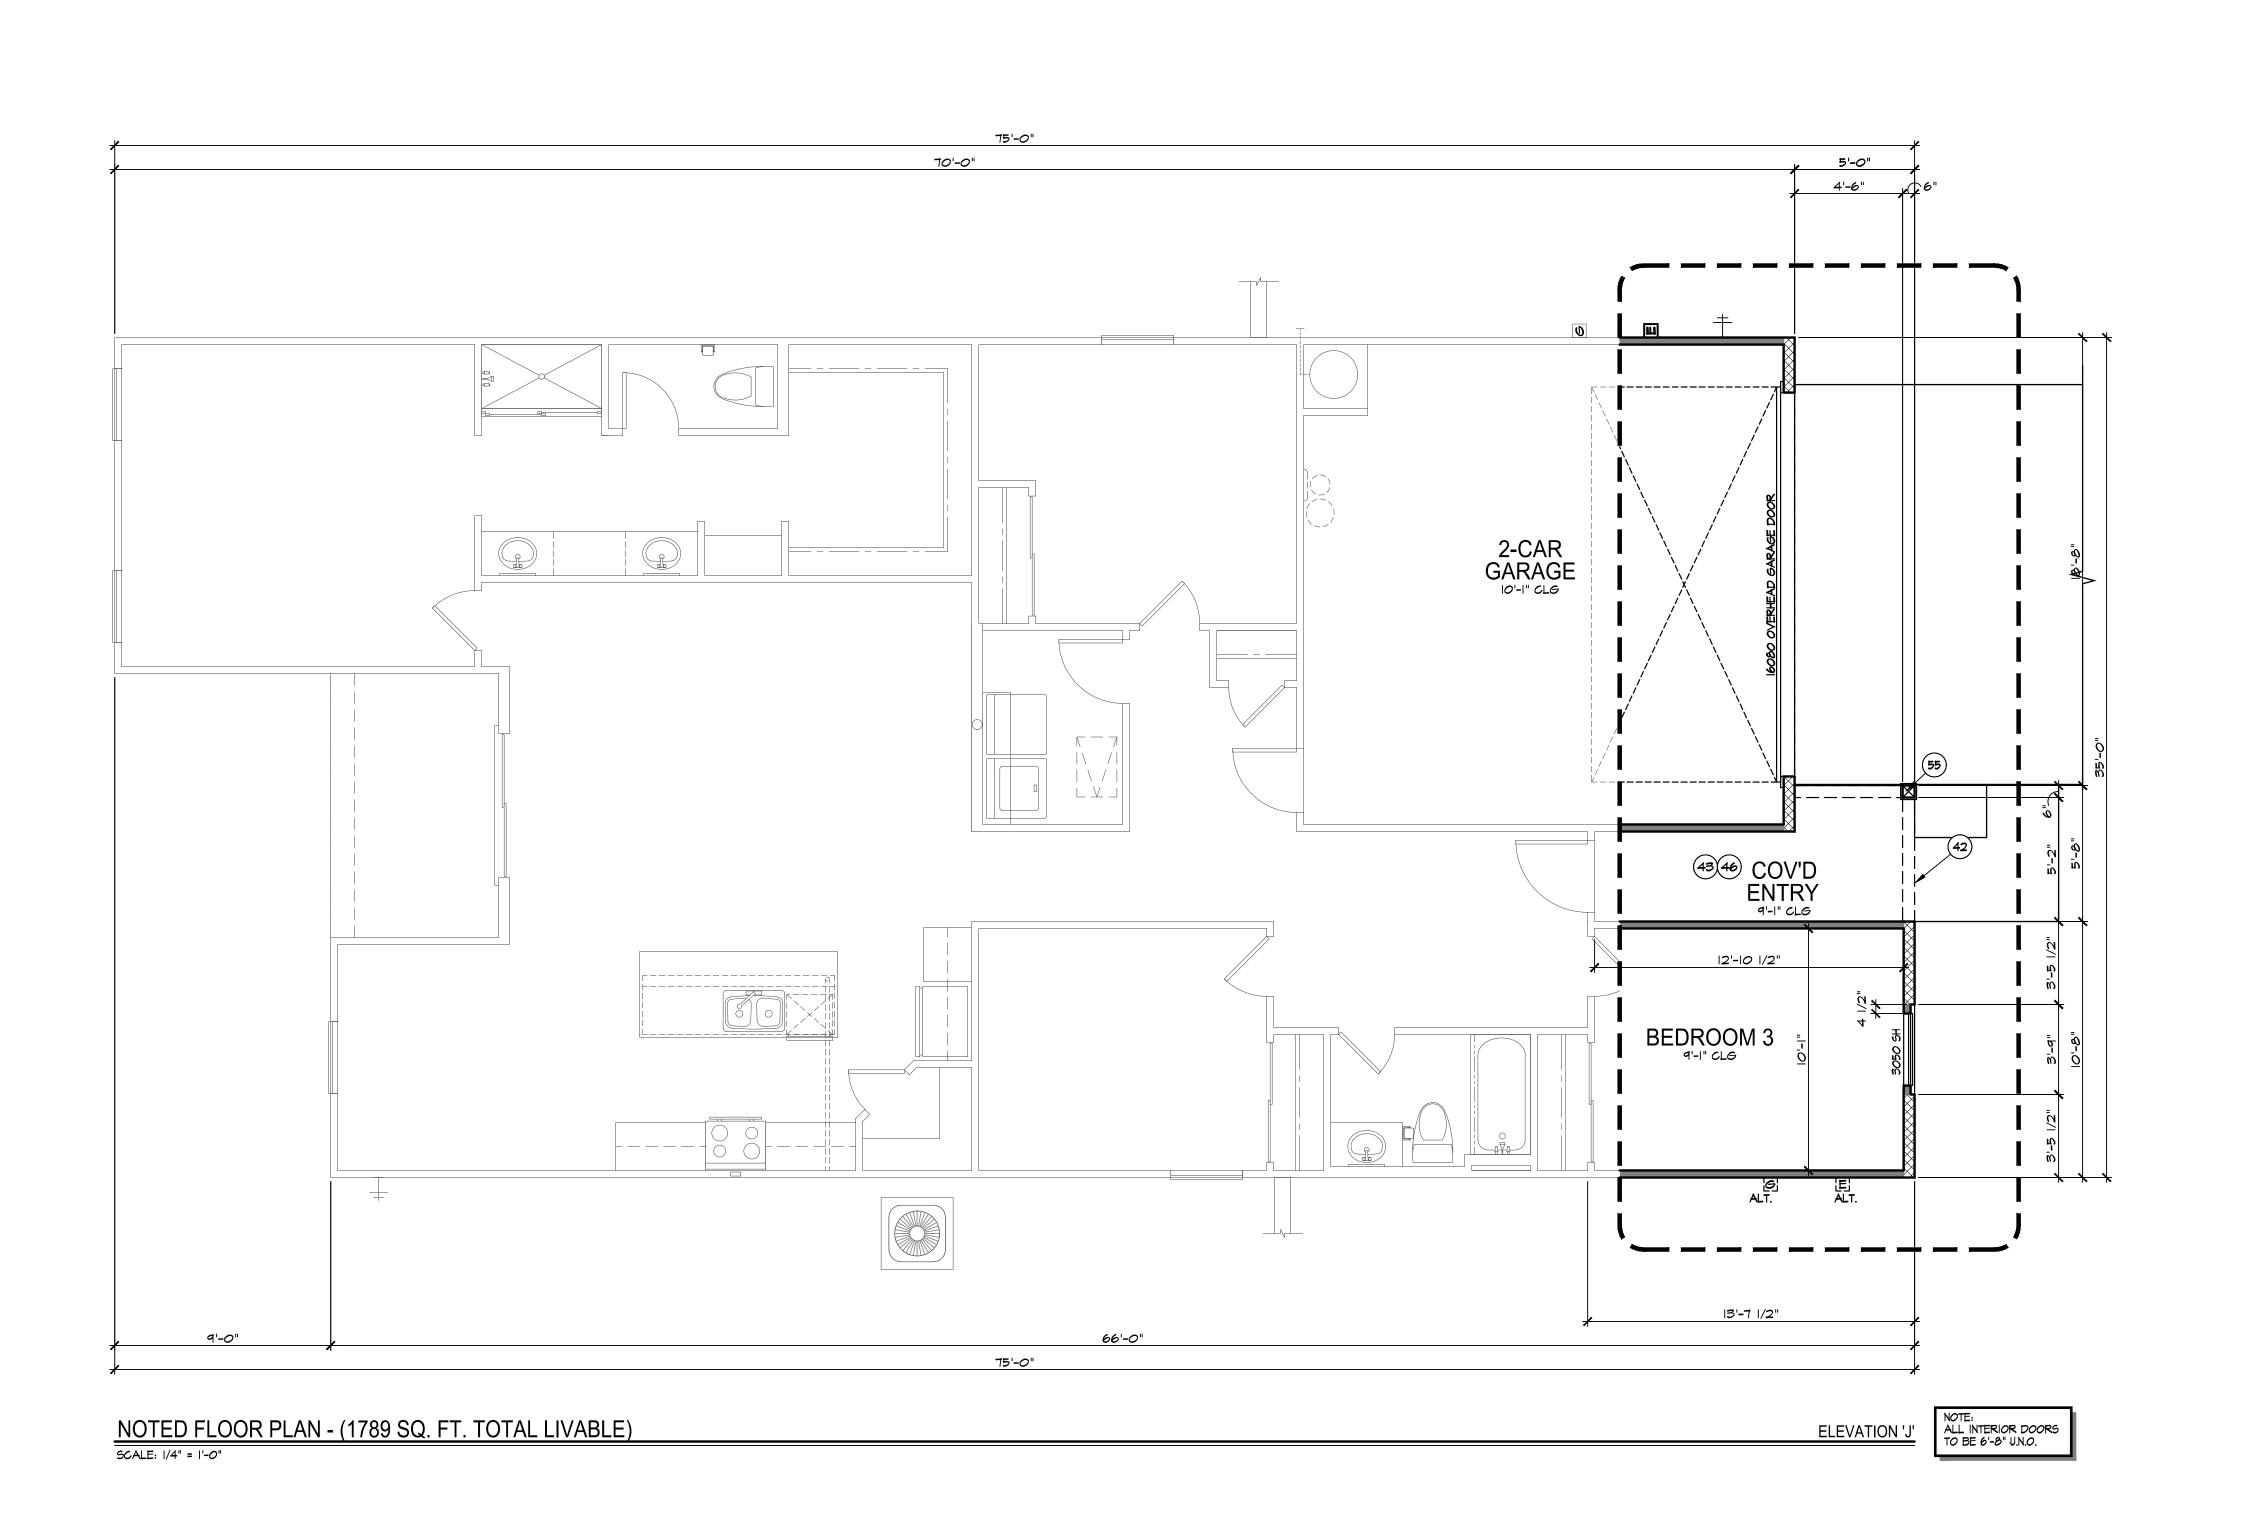
ART

MAIN

3520

SHEET No.

WALL LEGEND 2X4 FRAMED WALL 2X6 FRAMED WALL 2X8 FRAMED WALL



ONDUIT UNDER SLAB FOR ELECTRICAL TO ISLAND

(2) UPPER CABINETS

(3) LOWER CABINETS (4) OPTIONAL UPPER CABINETS

(5) OPTIONAL LOWER CABINETS

6 OPTIONAL BUILT-IN CABINET - PROVIDE DROPPED SOFFIT, TIGHT AND FLUSH WITH TOP OF UPPER CABINETS.

7 OPTIONAL BUILT-IN CABINET - PROVIDE DBL. 2X4 WING WALL, 29" DP., AS INDICATED ON PLANS, TIGHT AND FLUSH WITH END CABINET

(8) TALL BOY CABINET - OPT'L IF DASHED 9 KNEE SPACE BELOW COUNTER TOP - MINIMUM OF 3'-O" CLEAR WIDTH

FACE FRAME CABINET - PER CABINET MANUFACTURER STORAGE BENCH WITH HOOKS ABOVE - OPT'L IF DASHED

(12) VALET CABINETS - OPT'L IF DASHED SEAT/BENCH - HEIGHT AS NOTED - AT SHOWER, SLOPE TO DRAIN. OPT'L IF DASHED.

 $oxedsymbol{(15)}$ $oxedsymbol{(6)}$ 16" SHELF STANDARD - OPT'L UPPER CABINETS (16) SHELF - SIZE AS NOTED

(14) 4 SHELVES - REFER TO DETAIL 19/DI.6

 (Π) ONE ROD / ONE SHELF - REFER TO DET. 12/D1.6 TWO RODS / TWO SHELVES - REFER TO DET. 12/D1.6

(19) 5 SHELF SHOE RACK - REFER TO DET. 16/D1.6 (20) STRUCTURED WIRE RECESSED BOX (21) DRY-OFF DECK

GLASS PANEL TO SIT ON TOP OF TUB DECK AND FLUSH W INNER EDGE. NO LEDGE. 23) 18" X 18" ACCESS PANEL LOCATION FOR JACUZZI TUB - OPT'L. IF DASHED

24) LOW WALL - HEIGHT AS NOTED (36" HIGH MIN.) - OPT'L IF INDICATED 'OPT.' REFER TO DETAILS 7/DI.7 AND 8/DI.7.

HANDRAIL/GUARDRAIL - GUARDRAIL 36" MIN. REFER TO DETAILS 1/DI.1 THROUGH 12/DI.1 (26) WROUGHT IRON RAILING - PROVIDE VERTICAL 2x6 SOLID BLOCKING EACH END, SET BACK I 3/4" FROM FACE OF COLUMN OR CORNER

OPTIONAL RAILING I.L.O. LOW WALL - 36" HIGH MIN. - REFER TO DETAILS II/DI.7 AND 12/DI.7 (28) FLAT SOFFIT - 8'-1" AT FIRST FLOOR U.N.O. - 7'-I" AT SECOND FLOOR U.N.O.

29 PROVIDE OPTION FOR DOUBLE REFRIG. I.L.O. STANDARD REFRIG. SHOWN - COORDINATE ALT. CABINET CONFIGURATION W/ CABINET MANUFACTURER.

OPTION FOR UNDER COUNTER REFRIG. OR FULL SIZE REFRIG. I.L.O. SHELVING IN THIS LOCATION (31) TRAY CEILING - HEIGHT PER PLAN - OPT'L IF

OPTIONAL GLASS LOW WALL WITH GUARDRAIL AND TEMPERED GLASS AT 36" A.F.F. MIN. -REFER TO STRUCTURAL AND GUARDRAIL CONTRACTOR DRAWINGS FOR DETAILS.

(34) LINE OF FLOORING CHANGE (35) PROVIDE DRYER MAKEUP AIR SEE DETAIL 16/DI.5 (36) WASHER

37) I-3/4" SOLID CORE DOOR, TIGHT FITTING, SELF-CLOSING, SELF-LATCHING WITH GASKETS AND SWEEP

OPENING PLUS 2" ON EACH SIDE AND 36" DEEP U.N.O. - OPT'L. IF DASHED THE FINISH CONCRETE AT EXTERIOR SIDE OF DOOR MUST BE WITH-IN 2" OF THRESHOLD

(4) TWO 14"W x 8"H HIGH/LOW VENTS AT +4" ABOVE STEM AND -4" BELOW CEILING @ GAS COMMUNITIES ONLY

43) 1/2" EXTERIOR RATED, SAG RESISTENT GYP. BD. AT PATIO/PORCH CEILING ICC ESR-1338

44) 5/8" TYP. 'X' GYP. BD. AT USEABLE AREAS UNDER STAIRS, BEARING WALLS, AND GARAGE WALLS/CEILING

(45) 1/8" SLOPE PER 1'-0" (46) 1/4" SLOPE PER 1'-0"

(47) MECHANICAL CHASE (48) FIREBLOCK ALL VOIDS - TYP. T&P RELIEF VALVE AT +6" MAX ABOVE FLOOR OR WASTE RECEPTOR

(50) TEMPERED GLASS

51) SLOPE SHELF FOR POSITIVE DRAINAGE -PROVIDE THERMOPLASTIC WATER- PROOFING MEMBER 342)

52) GAS SHUT OFF VALVE @ GAS COMMUNITIES ONLY. - OPT'L. IF DASHED DIRECT VENT OR B-VENT GAS FIREPLACE.
REFER TO SHEET A4.2 - SHALL BE TESTED IN
ACCORDANCE WITH UL 127. - OPT'L. IF DASHED

(54) FIREPLACE GAS VALVES SHALL BE LOCATED OUTSIDE OF REQUIRED HEARTH AREA, BUT NO MORE THAN 12 INCHES FROM GAS OUTLET. (55) 6x6 ROUGH SAWN STRUCTURAL POST AND/OR

56 MEDIA WALL - REFER TO SHEET A4.2 - OPT'! IF DASHED

57) STONE / BRICK VENEER- REFER TO ELEVATIONS PROVIDE DEPRESSED SLAB FOR OPTIONAL PAVERS

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> DRAWN BY: Outhouse DATE: JAN. 1, 2025


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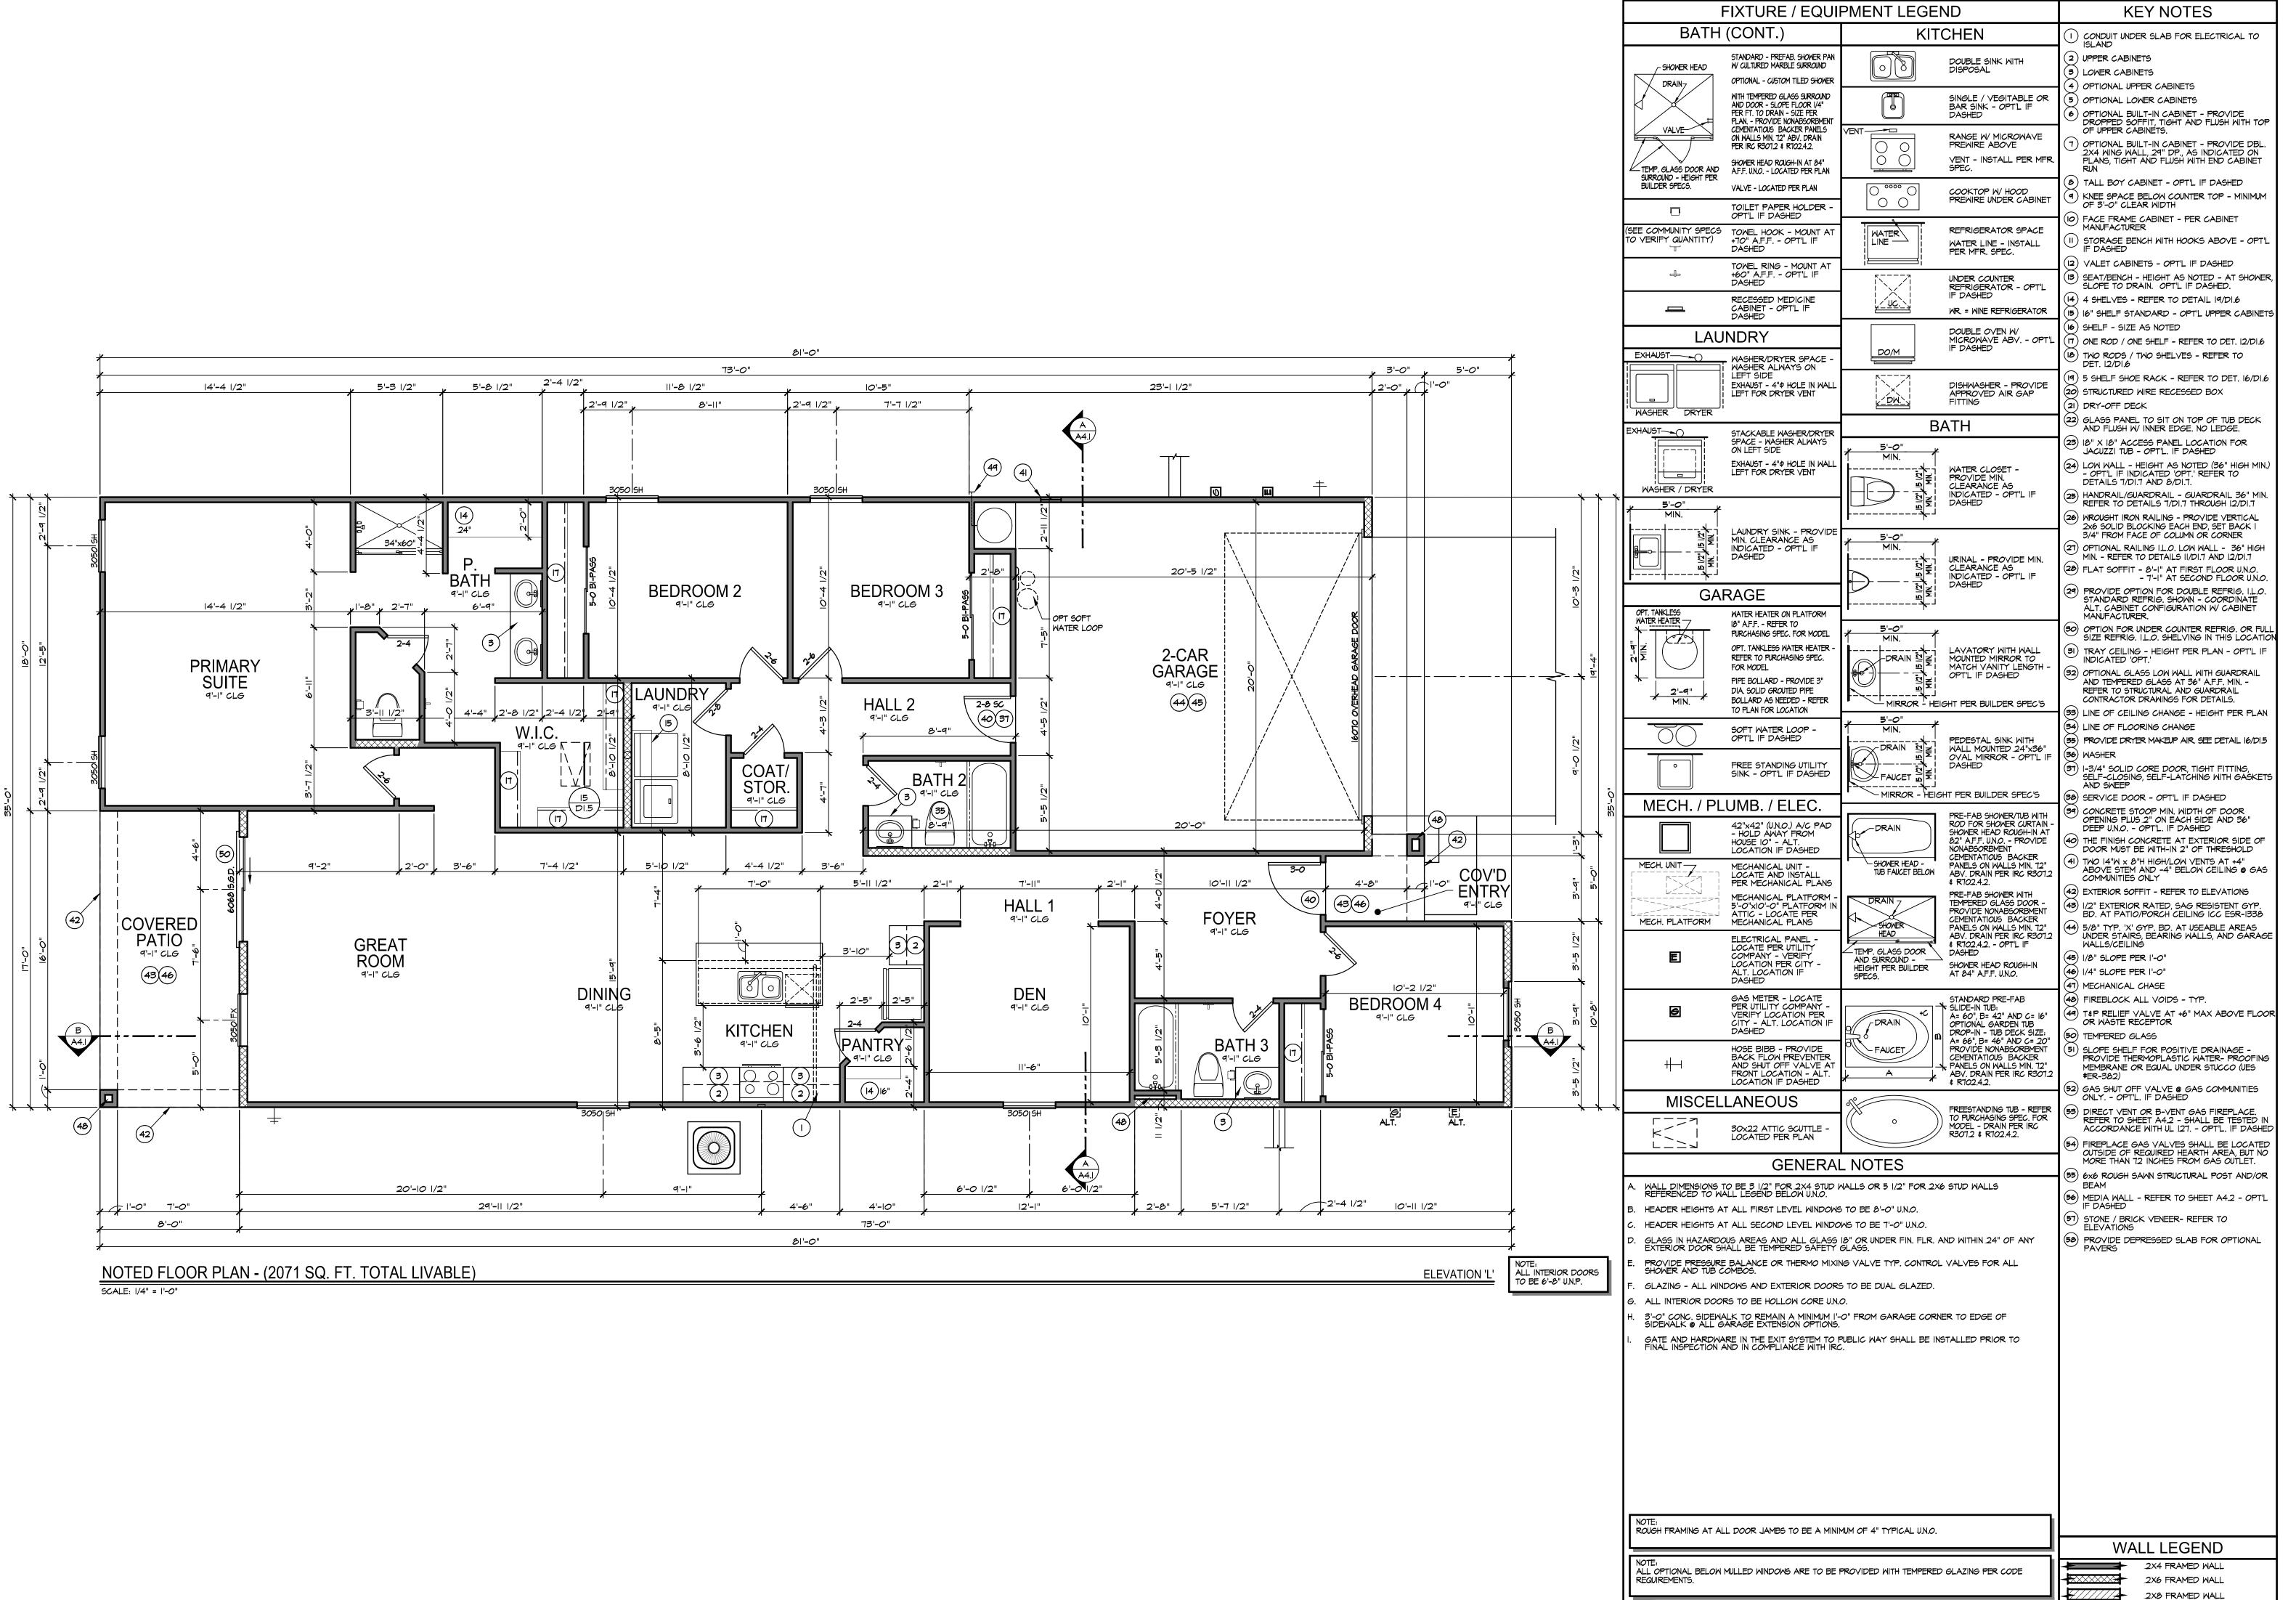
3520



SHEET No.

WALL LEGEND 2X4 FRAMED WALL 2X6 FRAMED WALL 2X8 FRAMED WALL



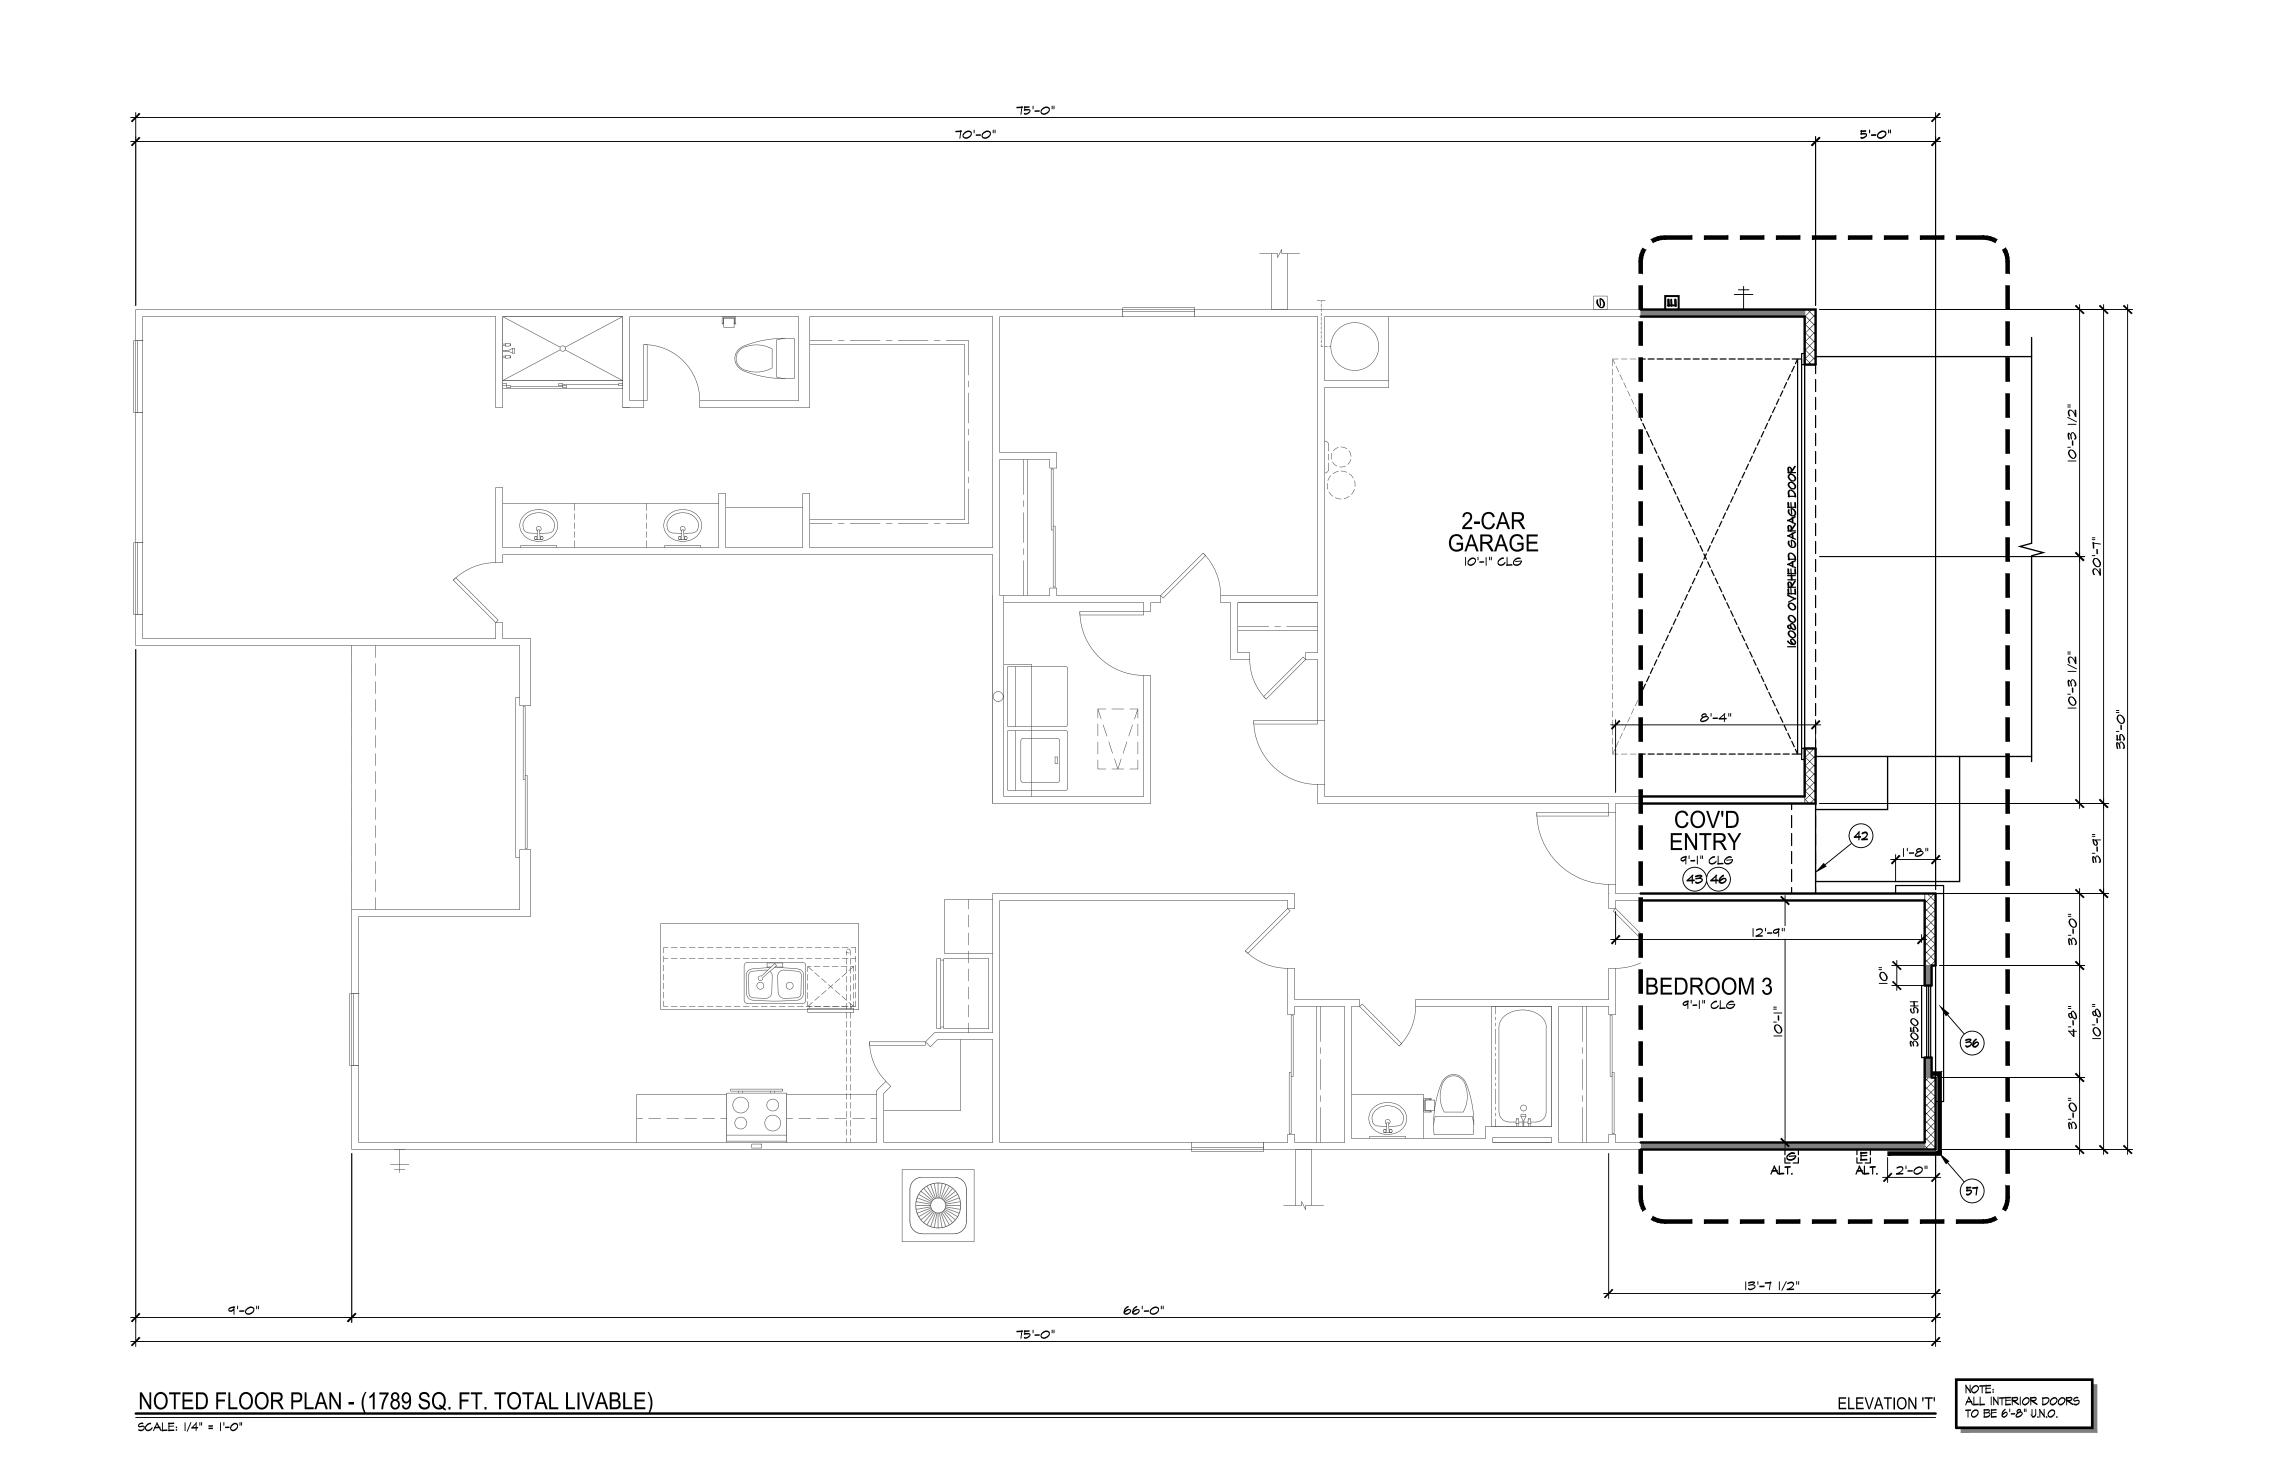



MAIN LEVEL NOTED FLOOR PLAN

PLAN# 3530

SHEET No.


A1.1

SUBDIVISION

SHEET No.

WALL LEGEND

2X4 FRAMED WALL 2X6 FRAMED WALL 2X8 FRAMED WALL

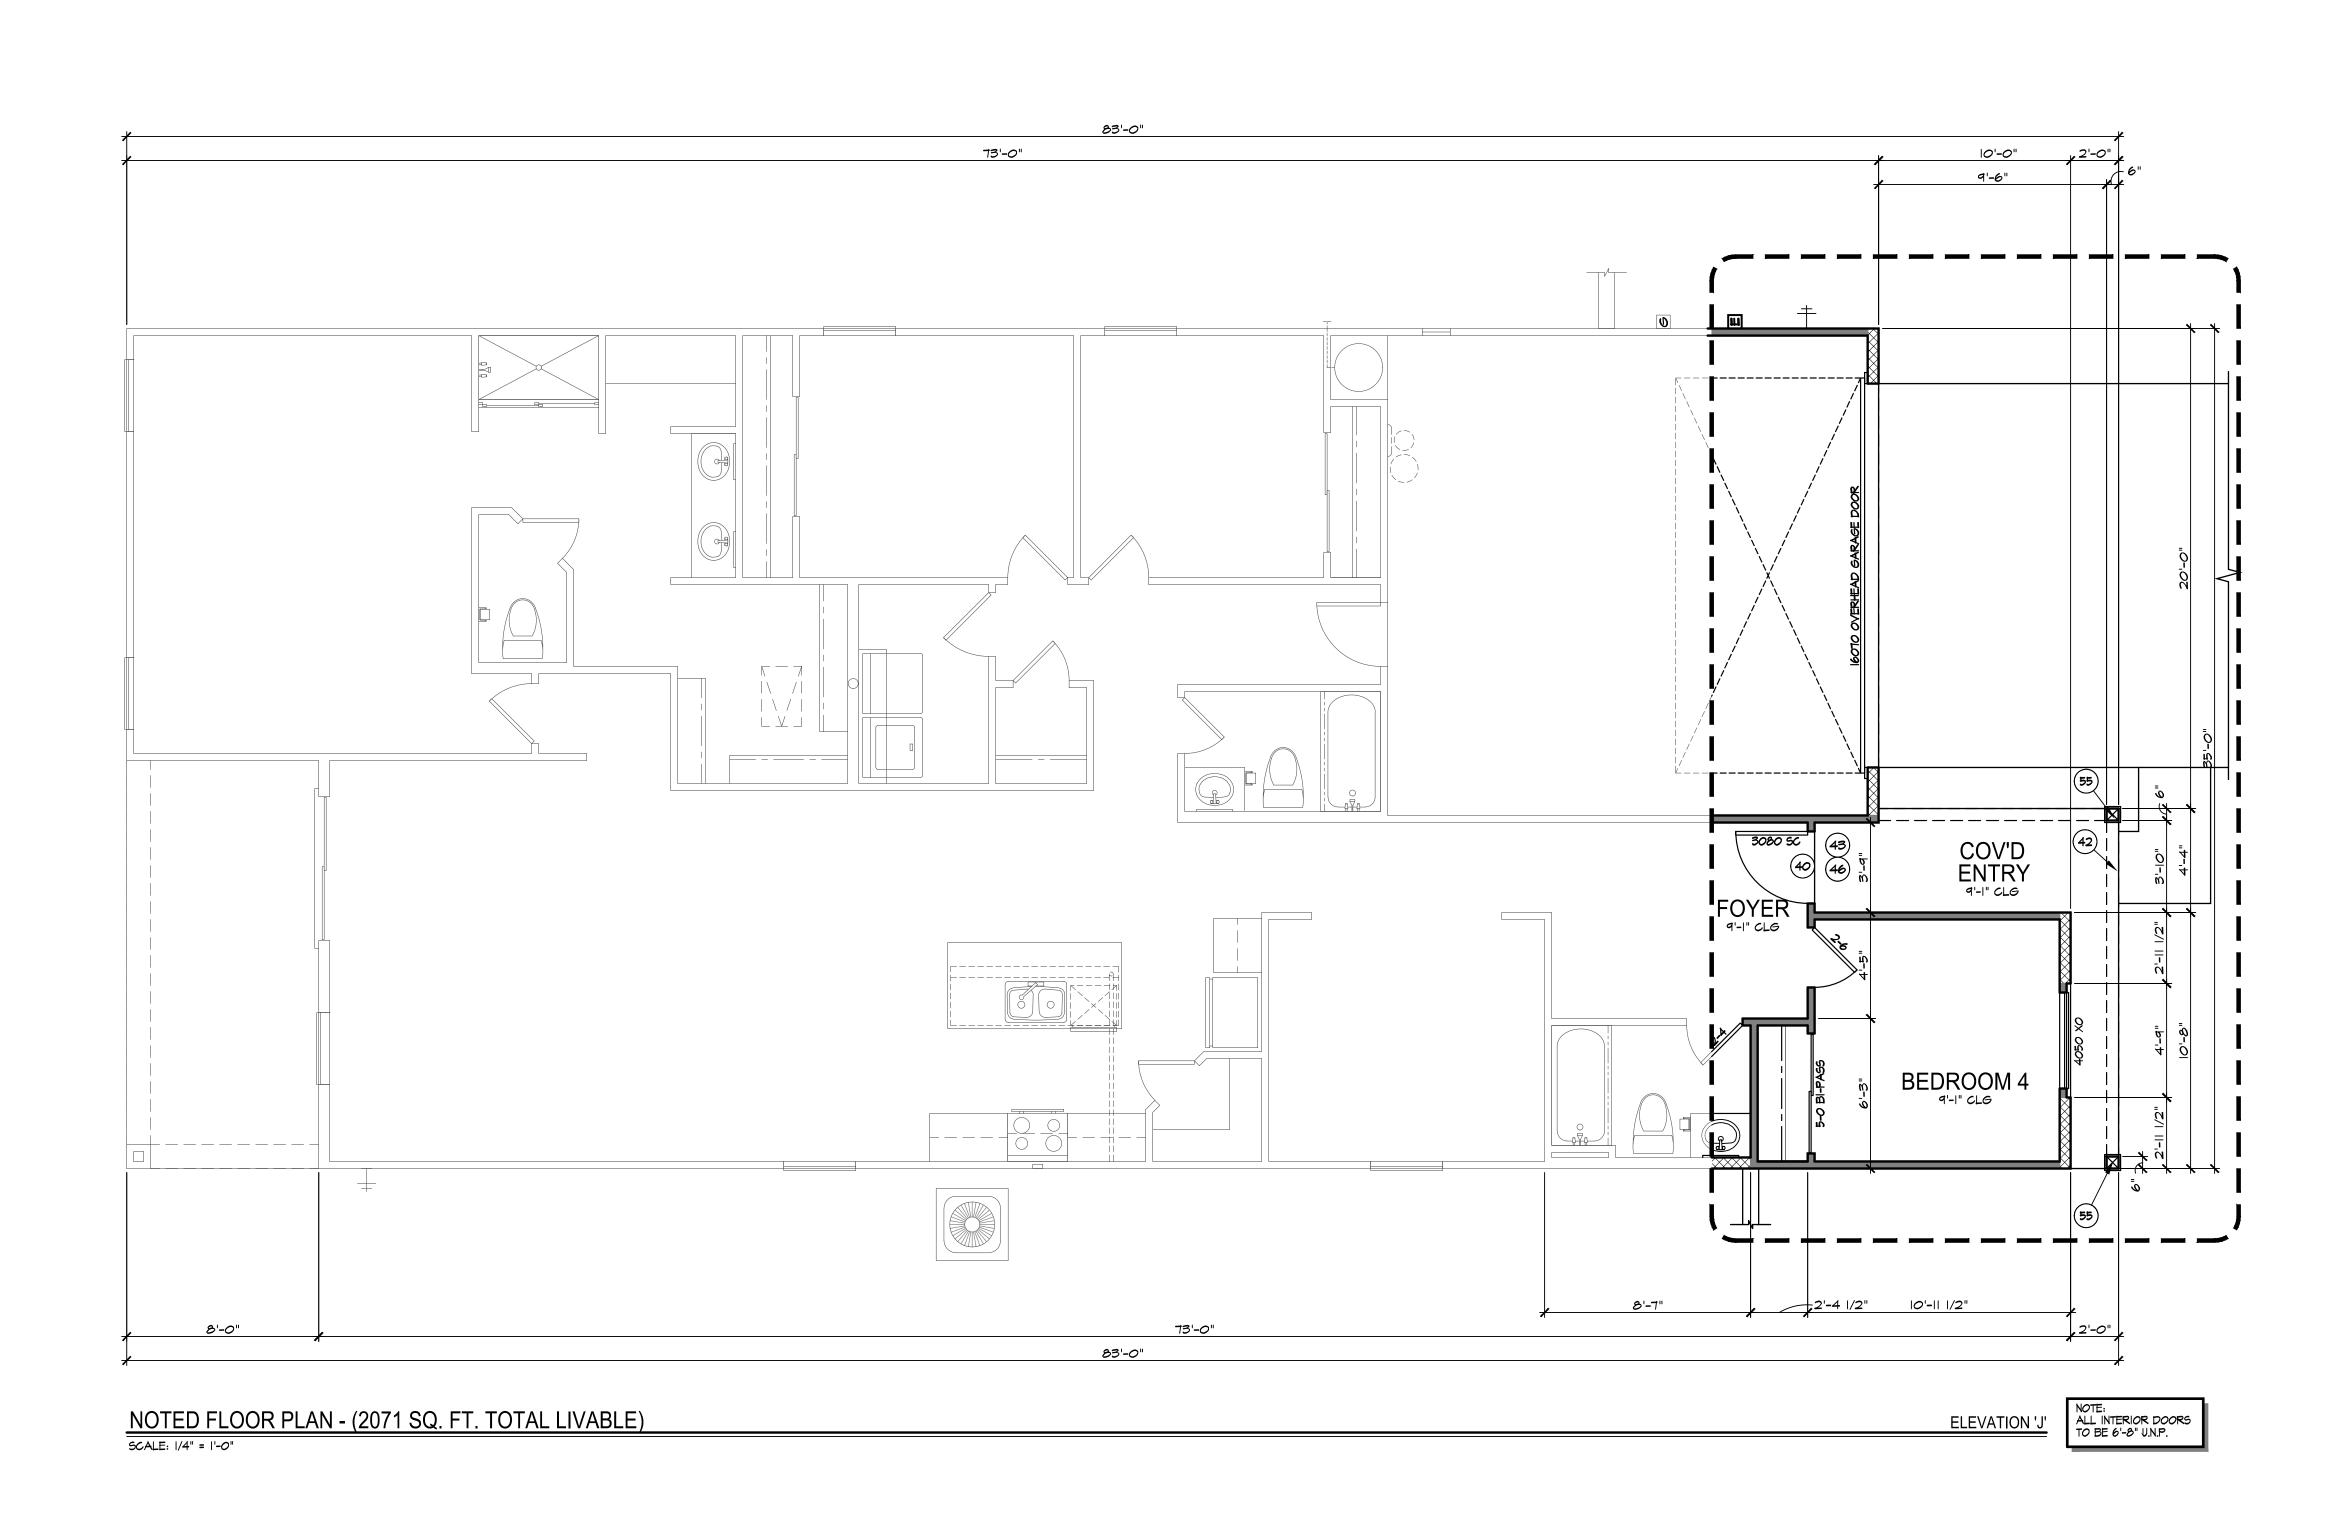

ONDUIT UNDER SLAB FOR ELECTRICAL TO ISLAND

(2) UPPER CABINETS

(3) LOWER CABINETS

(4) OPTIONAL UPPER CABINETS (5) OPTIONAL LOWER CABINETS

6 OPTIONAL BUILT-IN CABINET - PROVIDE DROPPED SOFFIT, TIGHT AND FLUSH WITH TOP OF UPPER CABINETS.

OPTIONAL BUILT-IN CABINET - PROVIDE DBL. 2X4 WING WALL, 29" DP., AS INDICATED ON PLANS, TIGHT AND FLUSH WITH END CABINET DIN (8) TALL BOY CABINET - OPT'L IF DASHED

(9) KNEE SPACE BELOW COUNTER TOP - MINIMUM OF 3'-O" CLEAR WIDTH

FACE FRAME CABINET - PER CABINET MANUFACTURER STORAGE BENCH WITH HOOKS ABOVE - OPT'L IF DASHED

(12) VALET CABINETS - OPT'L IF DASHED SEAT/BENCH - HEIGHT AS NOTED - AT SHOWER, SLOPE TO DRAIN. OPT'L IF DASHED.

(14) 4 SHELVES - REFER TO DETAIL 19/DI.6

(15) 16" SHELF STANDARD - OPT'L UPPER CABINETS (6) SHELF - SIZE AS NOTED (17) ONE ROD / ONE SHELF - REFER TO DET. 12/D1.6

TWO RODS / TWO SHELVES - REFER TO DET. 12/D1.6 (19) 5 SHELF SHOE RACK - REFER TO DET. 16/D1.6

(21) DRY-OFF DECK (22) GLASS PANEL TO SIT ON TOP OF TUB DECK AND FLUSH W/ INNER EDGE. NO LEDGE.

1'-6"

23) 18" X 18" ACCESS PANEL LOCATION FOR JACUZZI TUB - OPT'L. IF DASHED

24) LOW WALL - HEIGHT AS NOTED (36" HIGH MIN.) - OPT'L IF INDICATED 'OPT.' REFER TO DETAILS 7/DI.7 AND 8/DI.7. HANDRAIL/GUARDRAIL - GUARDRAIL 36" MIN. REFER TO DETAILS 1/DI.1 THROUGH 12/DI.1

(26) WROUGHT IRON RAILING - PROVIDE VERTICAL 2x6 SOLID BLOCKING EACH END, SET BACK I 3/4" FROM FACE OF COLUMN OR CORNER

OPTIONAL RAILING I.L.O. LOW WALL - 36" HIGH MIN. - REFER TO DETAILS II/DI.7 AND 12/DI.7 (28) FLAT SOFFIT - 8'-1" AT FIRST FLOOR UNO. - 7'-1" AT SECOND FLOOR U.N.O.

29 PROVIDE OPTION FOR DOUBLE REFRIG. I.L.O. STANDARD REFRIG. SHOWN - COORDINATE ALT. CABINET CONFIGURATION W/ CABINET MANUFACTURER. OPTION FOR UNDER COUNTER REFRIG. OR FULL SIZE REFRIG. I.L.O. SHELVING IN THIS LOCATION

(31) TRAY CEILING - HEIGHT PER PLAN - OPT'L IF OPTIONAL GLASS LOW WALL WITH GUARDRAIL AND TEMPERED GLASS AT 36" A.F.F. MIN. -

REFER TO STRUCTURAL AND GUARDRAIL CONTRACTOR DRAWINGS FOR DETAILS.

(35) PROVIDE DRYER MAKEUP AIR SEE DETAIL 16/DI.5

(37) I-3/4" SOLID CORE DOOR, TIGHT FITTING, SELF-CLOSING, SELF-LATCHING WITH GASKETS AND SWEEP

(4) TWO 14"M × 8"H HIGH/LOW VENTS AT +4" ABOVE STEM AND -4" BELOW CEILING @ GAS COMMUNITIES ONLY

43) 1/2" EXTERIOR RATED, SAG RESISTENT GYP. BD. AT PATIO/PORCH CEILING ICC ESR-1338

(46) 1/4" SLOPE PER 1'-0" (47) MECHANICAL CHASE

T&P RELIEF VALVE AT +6" MAX ABOVE FLOOR OR WASTE RECEPTOR

51) SLOPE SHELF FOR POSITIVE DRAINAGE -PROVIDE THERMOPLASTIC WATER- PROOFING MEMBRANE OR EQUAL UNDER STUCCO (UES

DIRECT VENT OR B-VENT GAS FIREPLACE.
REFER TO SHEET A4.2 - SHALL BE TESTED IN
ACCORDANCE WITH UL 127. - OPT'L. IF DASHED

(55) 6x6 ROUGH SAWN STRUCTURAL POST AND/OR

56 MEDIA WALL - REFER TO SHEET A4.2 - OPT'L IF DASHED

WALL LEGEND

2X4 FRAMED WALL 2X6 FRAMED WALL 2X8 FRAMED WALL

PROVIDE DEPRESSED SLAB FOR OPTIONAL PAVERS

SUBDIVISION

(33) LINE OF CEILING CHANGE - HEIGHT PER PLAN (34) LINE OF FLOORING CHANGE

(36) WASHER

(38) SERVICE DOOR - OPT'L IF DASHED OPENING PLUS 2" ON EACH SIDE AND 36" DEEP U.N.O. - OPT'L. IF DASHED THE FINISH CONCRETE AT EXTERIOR SIDE OF DOOR MUST BE WITH-IN 2" OF THRESHOLD

(42) EXTERIOR SOFFIT - REFER TO ELEVATIONS

44) 5/8" TYP. 'X' GYP. BD. AT USEABLE AREAS UNDER STAIRS, BEARING WALLS, AND GARAGE WALLS/CEILING

(45) 1/8" SLOPE PER 1'-0"


(48) FIREBLOCK ALL VOIDS - TYP.

(50) TEMPERED GLASS

52) GAS SHUT OFF VALVE @ GAS COMMUNITIES ONLY. - OPT'L. IF DASHED

FIREPLACE GAS VALVES SHALL BE LOCATED OUTSIDE OF REQUIRED HEARTH AREA, BUT NO MORE THAN 12 INCHES FROM GAS OUTLET.

57) STONE / BRICK VENEER- REFER TO ELEVATIONS

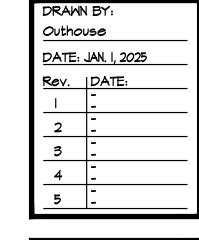


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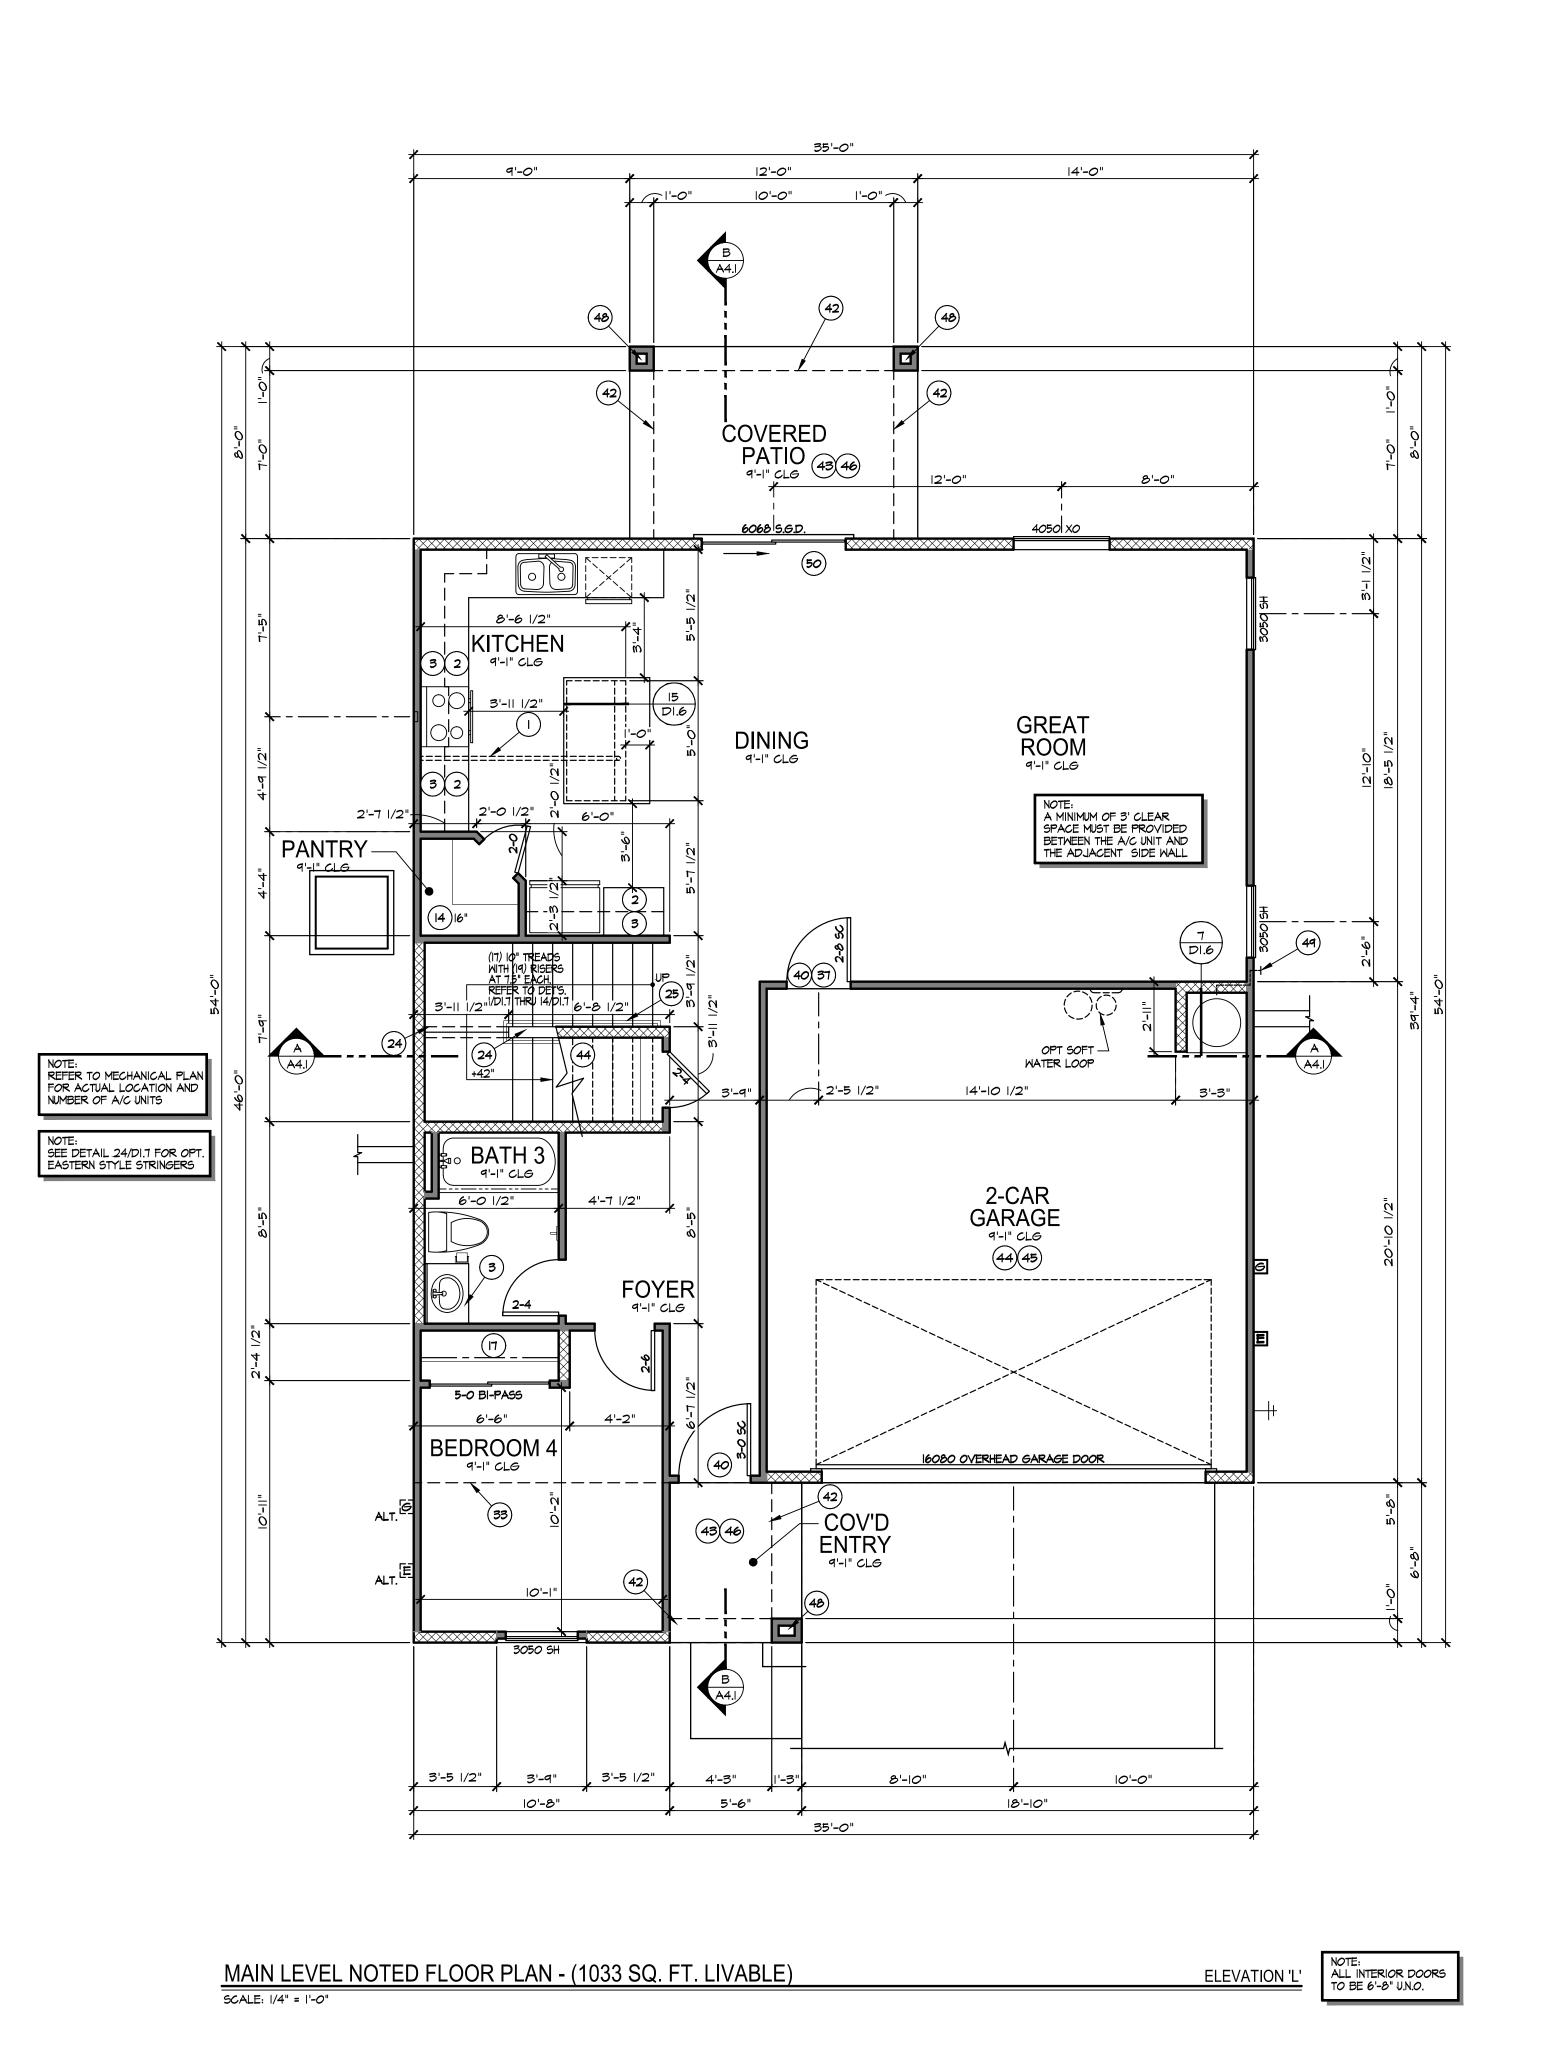





SHEET No.

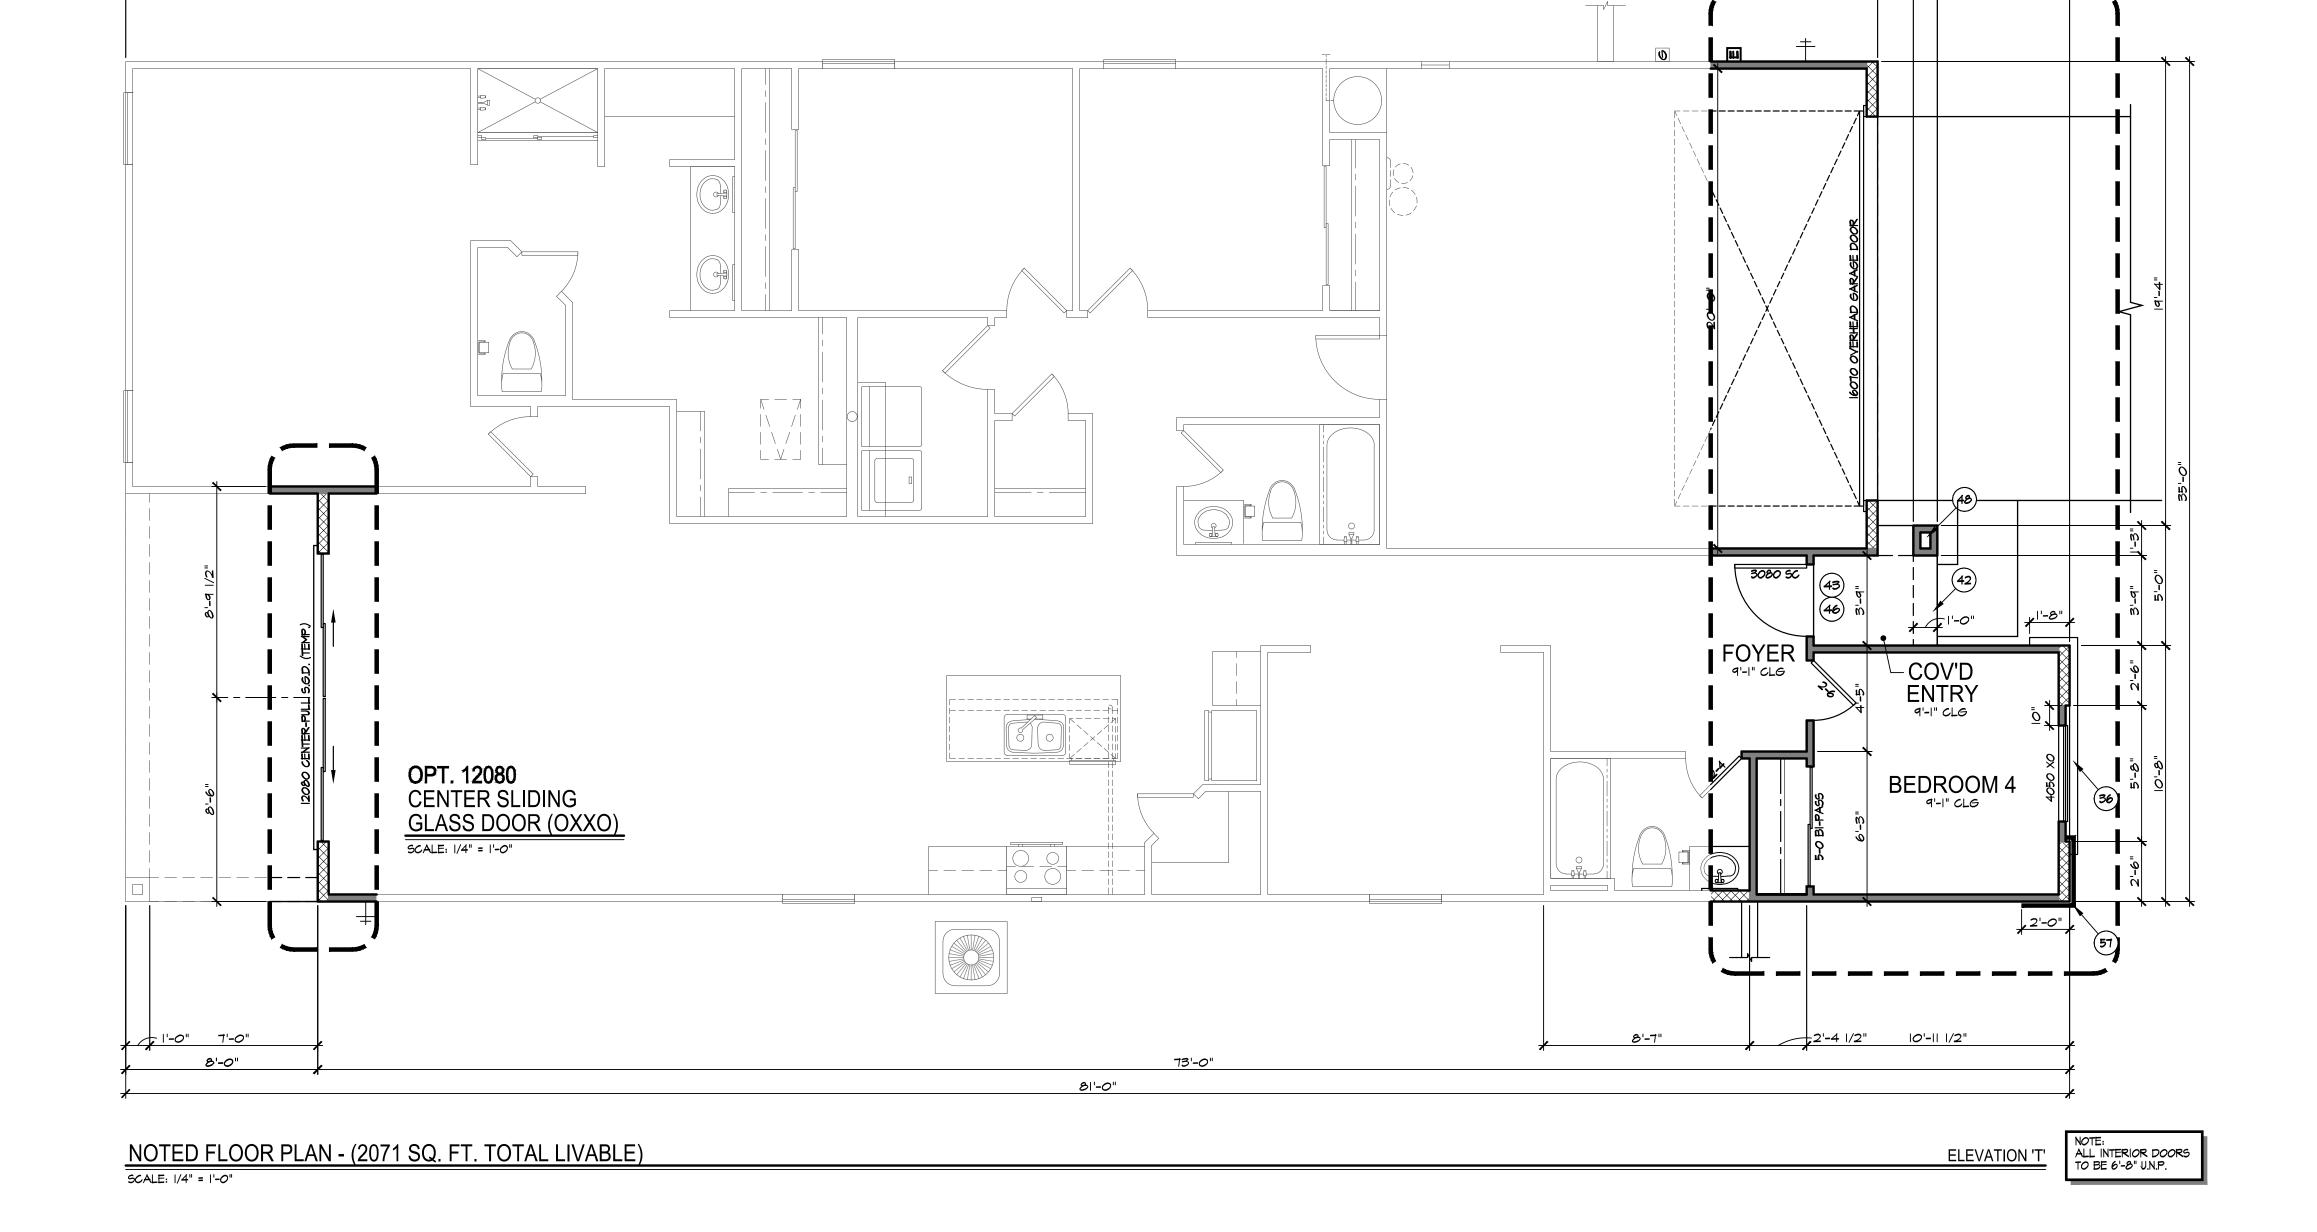

73'-0"



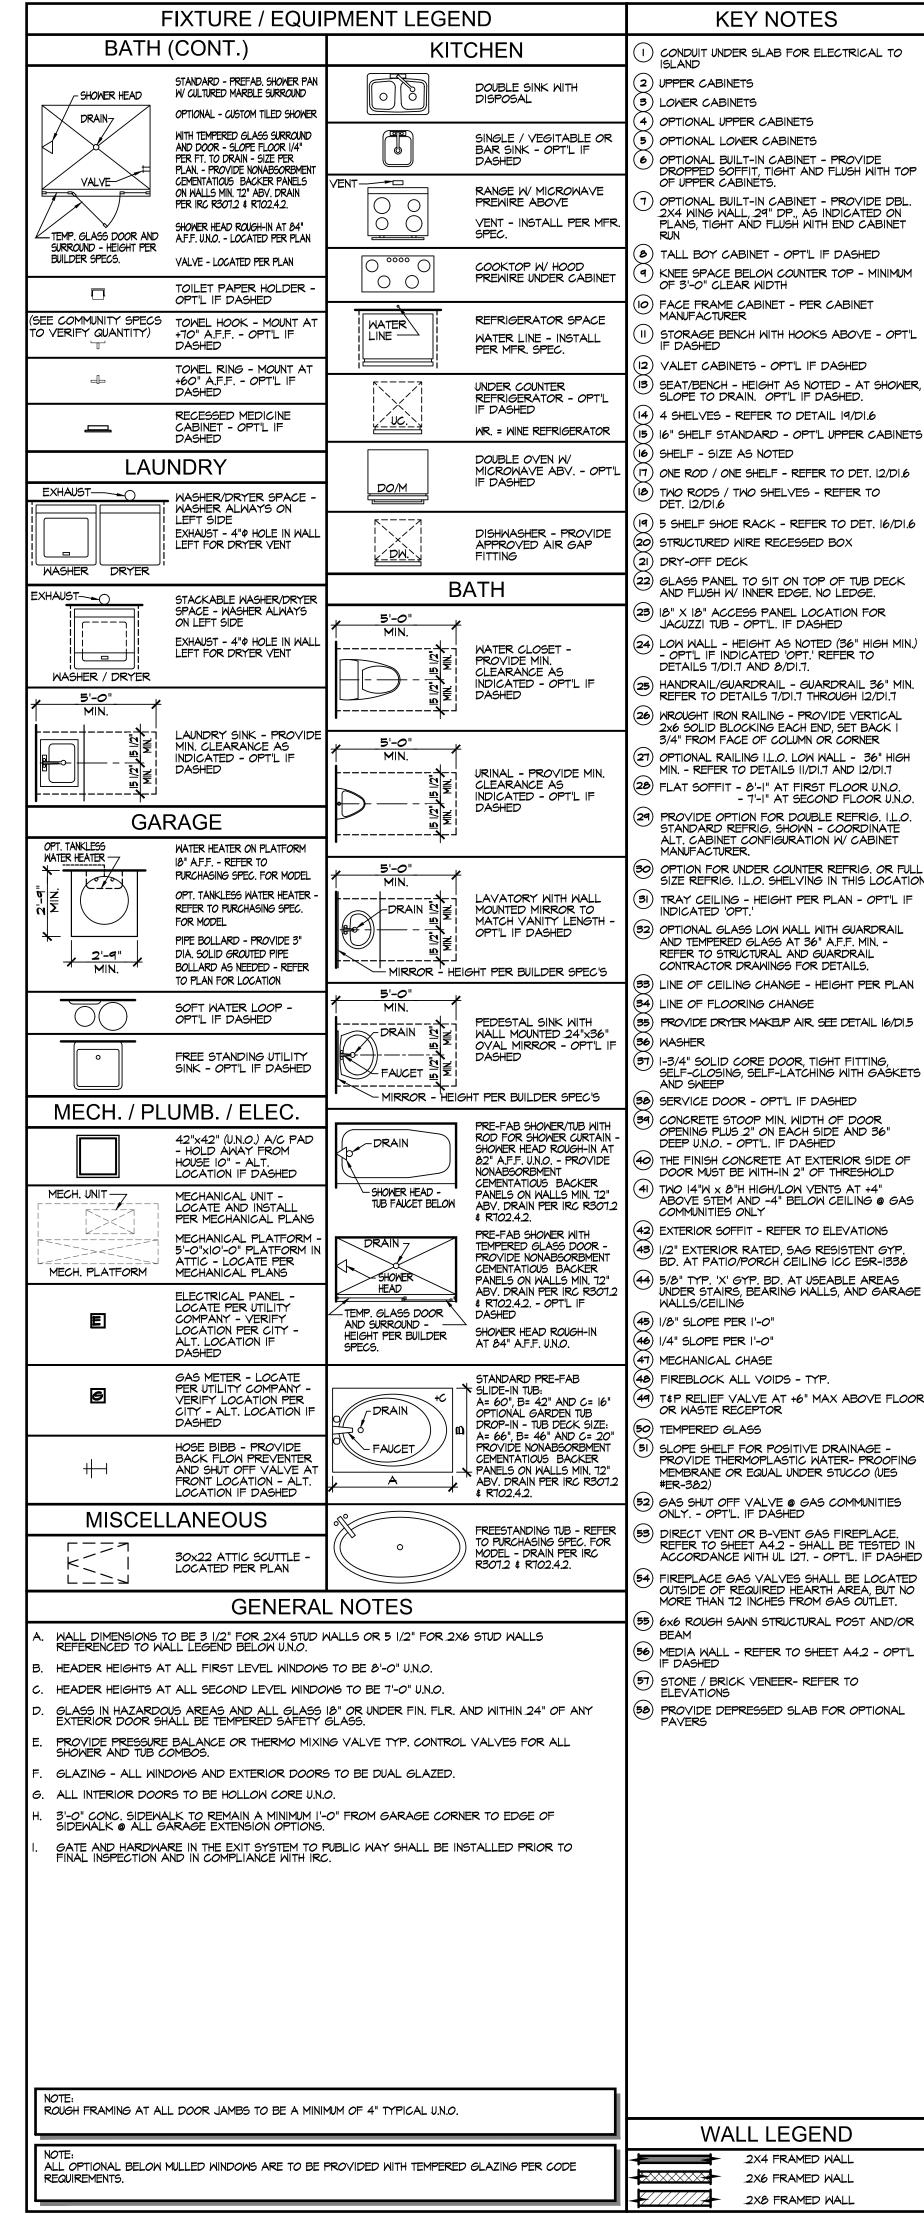




MAIN LEVEL NOTED FLO(ELEVATION 'L'

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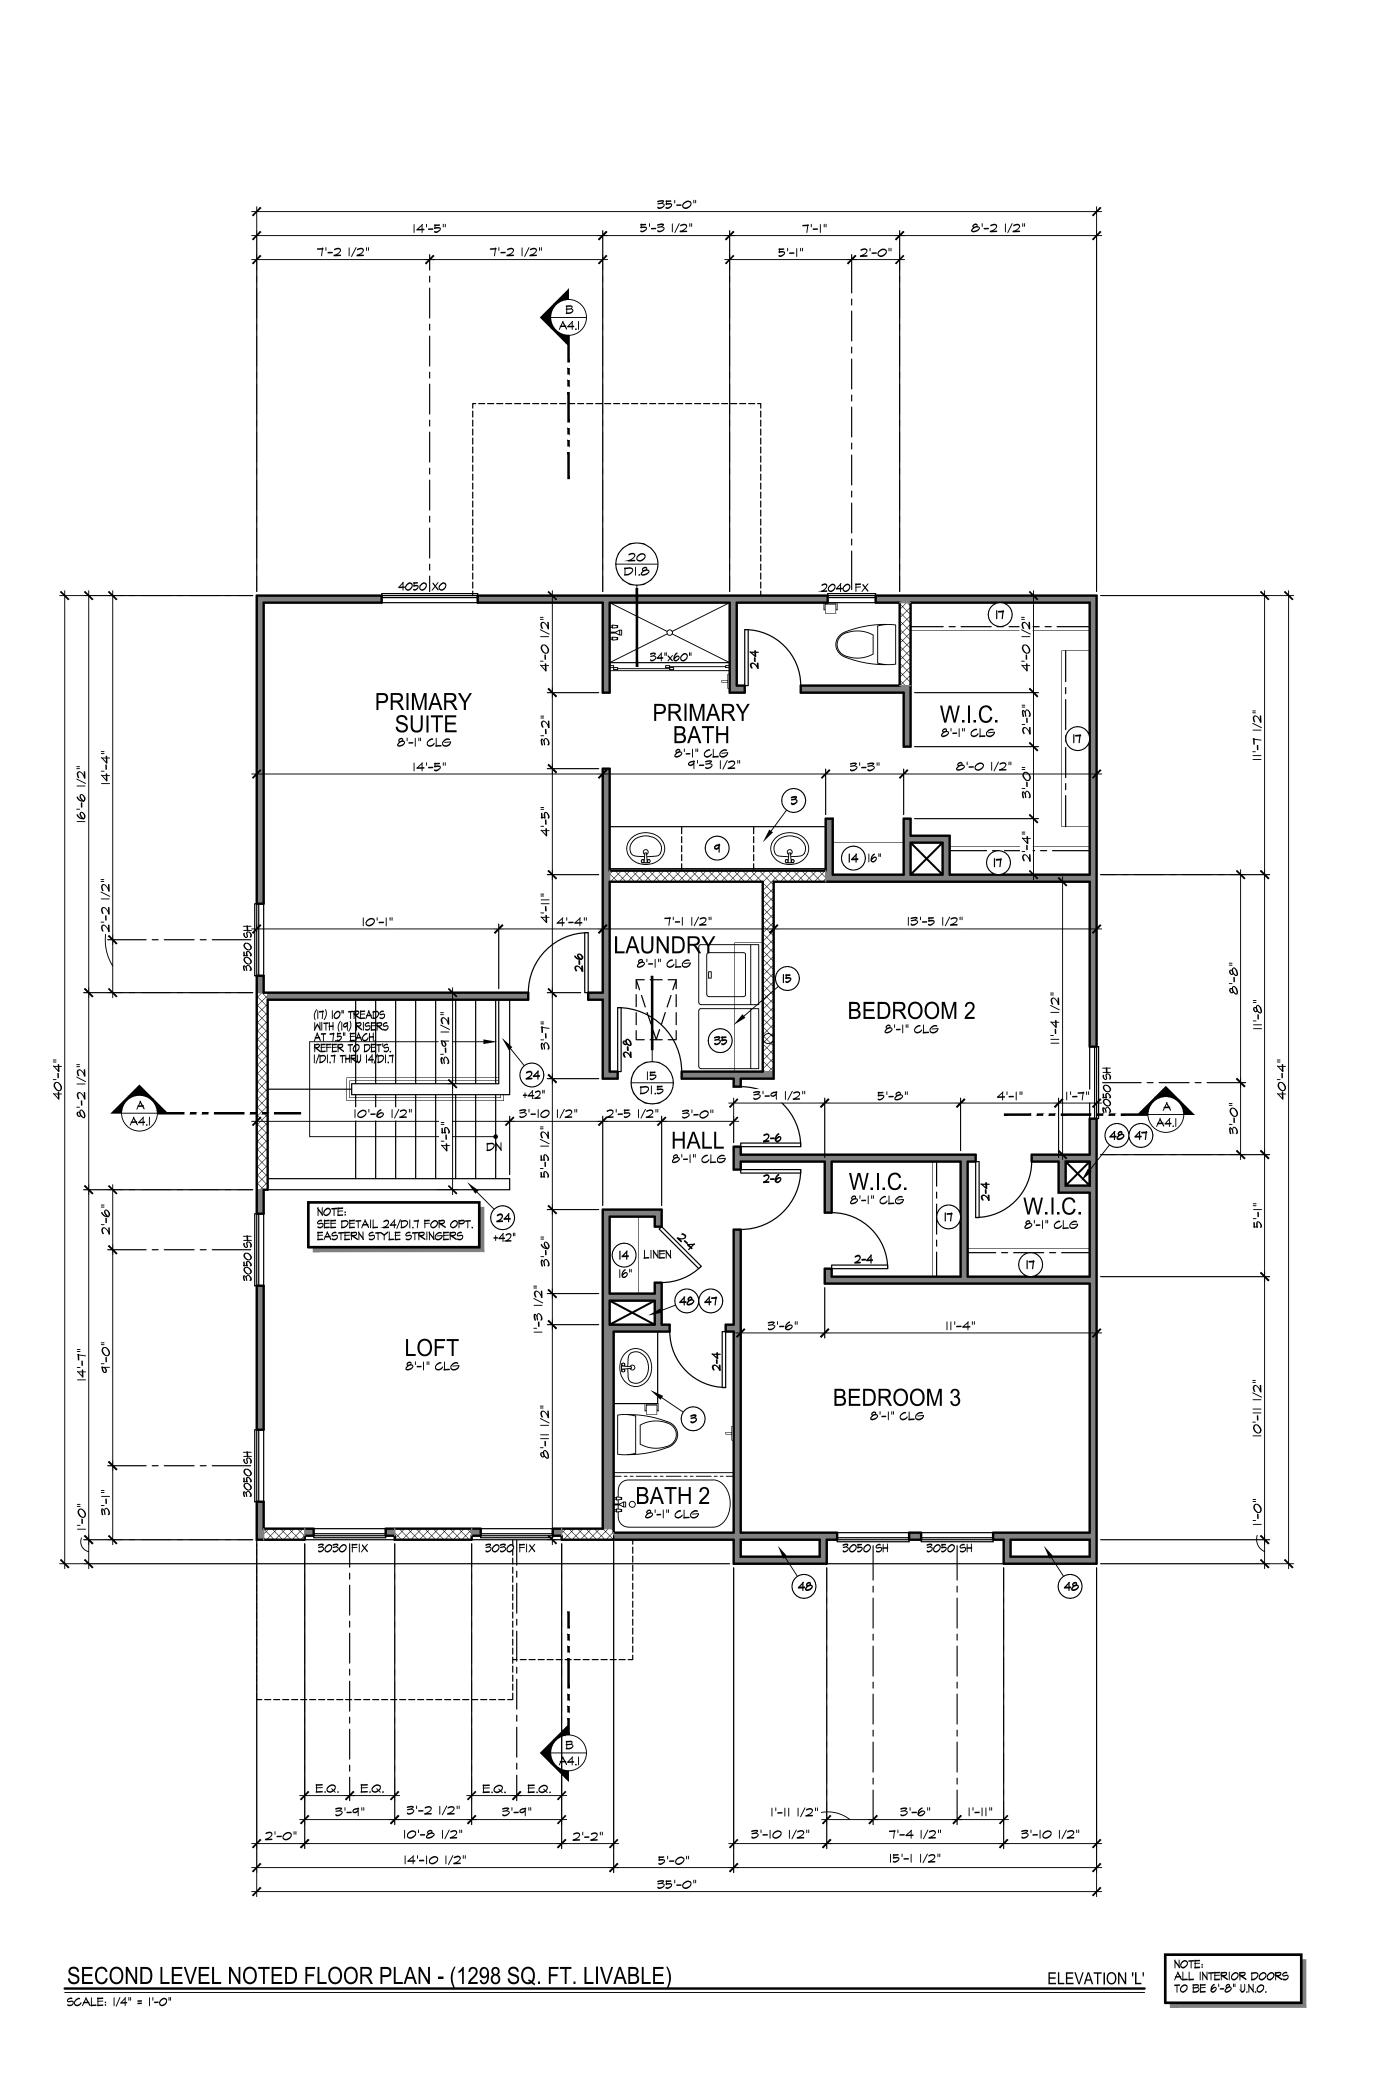
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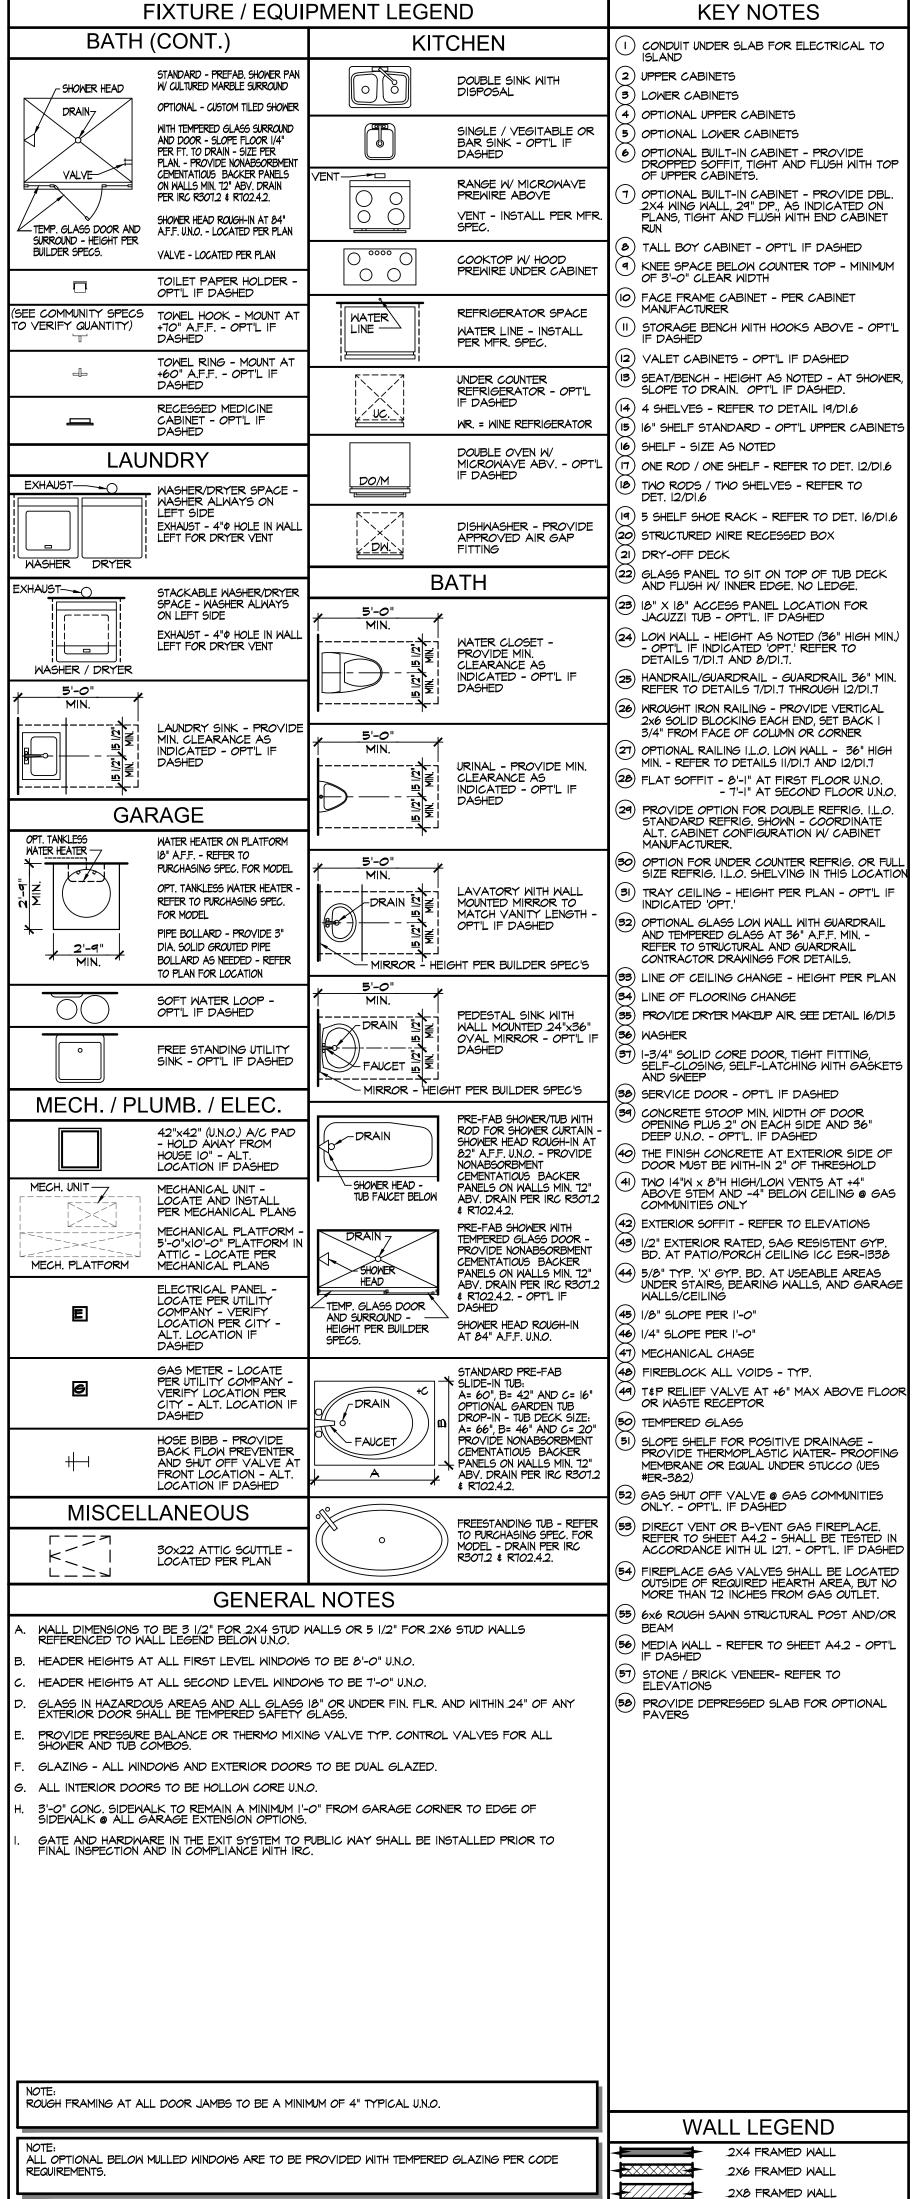


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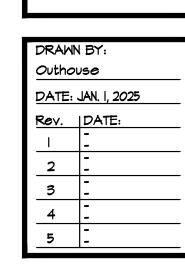


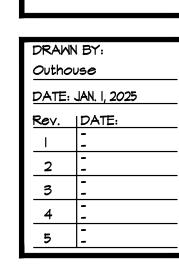



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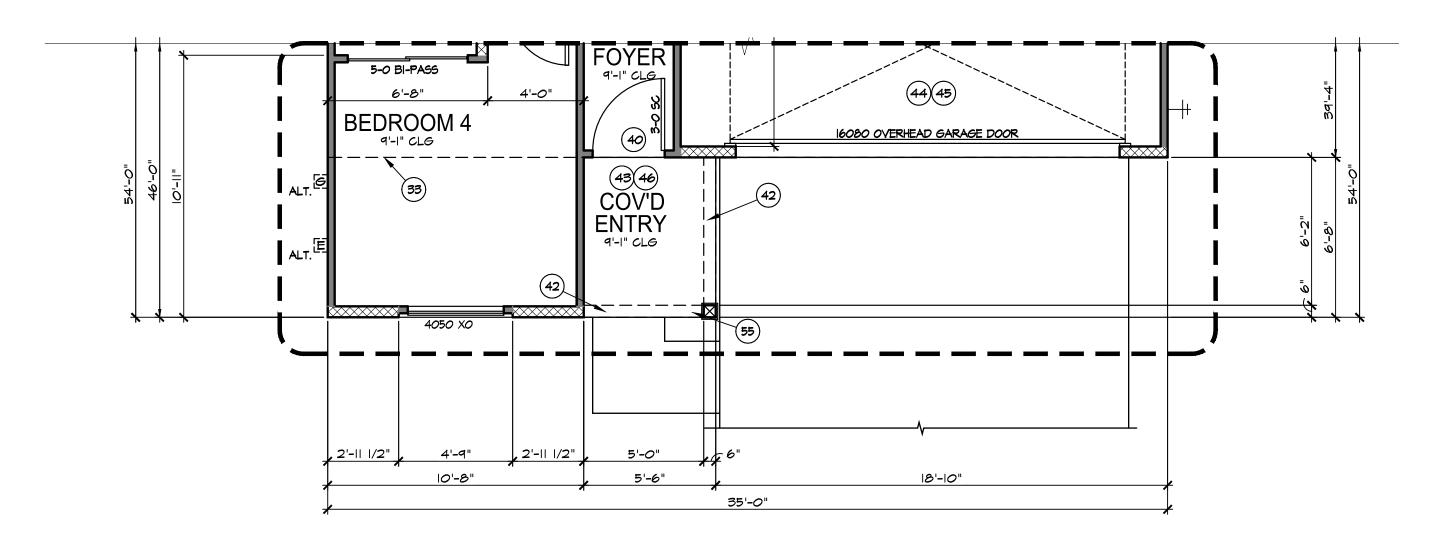



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SHEET No.

A1.2





MAIN LEVEL NOTED FLOOR PLAN - (1033 SQ. FT. LIVABLE)

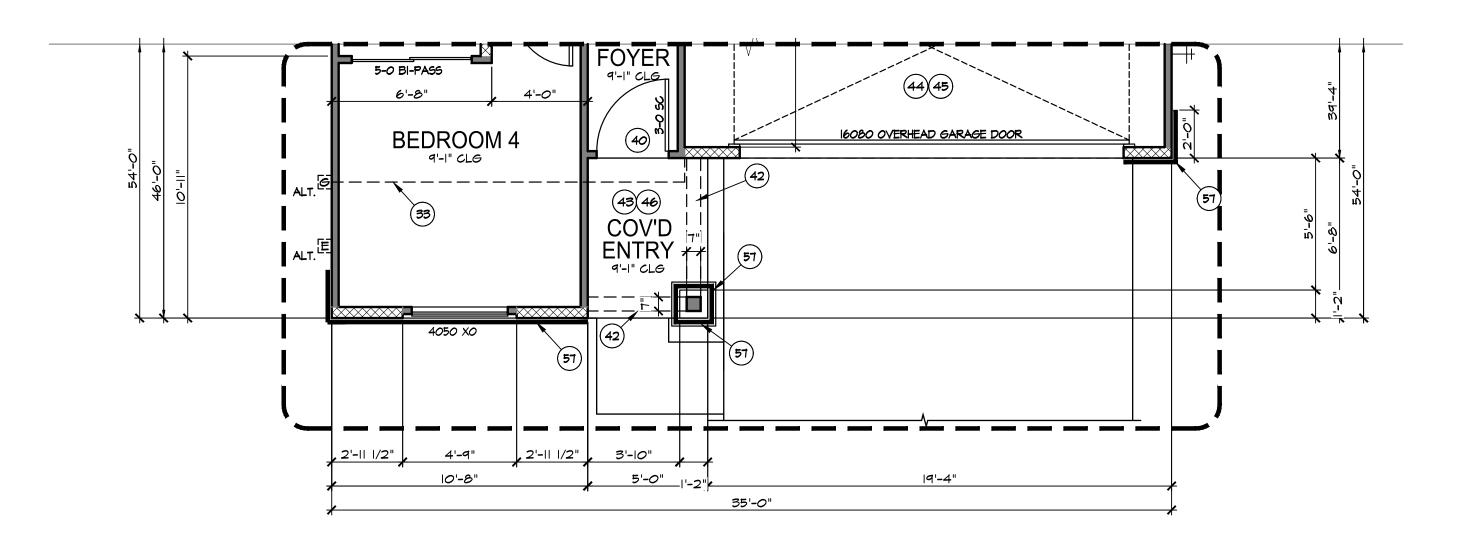SCALE: 1/4" = 1'-0"

MAIN LEVEL NOTED FLOOR PLAN - (1033 SQ. FT. LIVABLE)

NOTE: ALL INTERIOR DOORS TO BE 6'-8" U.N.O.

ELEVATION 'D'

ALL INTERIOR DOORS


ELEVATION 'J'

FIXTURE / EQUIPMENT LEGEND **KEY NOTES** BATH (CONT.) **KITCHEN** CONDUIT UNDER SLAB FOR ELECTRICAL TO ISLAND STANDARD - PREFAB, SHOWER PA W CULTURED MARBLE SURROUND 2) UPPER CABINETS DOUBLE SINK WITH (\mathfrak{z}) Lower cabinets OPTIONAL - CUSTOM TILED SHOWER DRAIN-(4) OPTIONAL UPPER CABINETS WITH TEMPERED GLASS SURROUND (5) OPTIONAL LOWER CABINETS AND DOOR - SLOPE FLOOR 1/4" BAR SINK - OPT'L IF OPTIONAL BUILT-IN CABINET - PROVIDE DROPPED SOFFIT, TIGHT AND FLUSH WITH TOP OF UPPER CABINETS. PER FT. TO DRAIN - SIZE PER DASHED PLAN. - PROVIDE NONABSORBME CEMENTATIOUS BACKER PANELS RANGE W/ MICROWAVE PREWIRE ABOVE ON WALLS MIN. 72" ABV. DRAIN OPTIONAL BUILT-IN CABINET - PROVIDE DBL. 2X4 WING WALL, 29" DP., AS INDICATED ON PLANS, TIGHT AND FLUSH WITH END CABINET PER IRC R301.2 \$ R102.4.2. VENT - INSTALL PER MFR. SHOWER HEAD ROUGH-IN AT 84" LEMP. GLASS DOOR AND A.F.F. U.N.O. - LOCATED PER PLAN SURROUND - HEIGHT PER (8) TALL BOY CABINET - OPT'L IF DASHED BUILDER SPECS. VALVE - LOCATED PER PLAN KNEE SPACE BELOW COUNTER TOP - MINIMUM
 OF 3'-O" CLEAR WIDTH PREWIRE UNDER CABINET TOILET PAPER HOLDER OPT'L IF DASHED FACE FRAME CABINET - PER CABINET MANUFACTURER (SEE COMMUNITY SPECS TOWEL HOOK - MOUNT AT TO VERIFY QUANTITY) +70" A.F.F. - OPT'L IF REFRIGERATOR SPACE WATER LINE) STORAGE BENCH WITH HOOKS ABOVE - OPT'L WATER LINE - INSTALL PER MFR. SPEC. DASHED 12) VALET CABINETS - OPT'L IF DASHED TOWEL RING - MOUNT A' +60" A.F.F. - OPT'L IF (13) SEAT/BENCH - HEIGHT AS NOTED - AT SHOWER, SLOPE TO DRAIN. OPT'L IF DASHED. REFRIGERATOR - OPT'L IF DASHED 14) 4 SHELVES - REFER TO DETAIL 19/DI.6 CABINET - OPT'L IF WR. = WINE REFRIGERATOR (15) 16" SHELF STANDARD - OPT'L UPPER CABINETS (16) SHELF - SIZE AS NOTED LAUNDRY MICROWAVE ABV. - OPT'L (17) ONE ROD / ONE SHELF - REFER TO DET. 12/D1.6 IF DASHED EXHAUST-(B) TWO RODS / TWO SHELVES - REFER TO WASHER/DRYER SPACE DET. 12/D1.6 MASHER ALWAYS ON LEFT SIDE $\mathsf{I9})$ 5 SHELF SHOE RACK - REFER TO DET. $\mathsf{I6}/\mathsf{D1}.6$ EXHAUST - 4"\$\text{\$\text{POLE IN WALL}}
LEFT FOR DRYER VENT (20) STRUCTURED WIRE RECESSED BOX APPROVED AIR GAP (21) DRY-OFF DECK WASHER DRYER 22) GLASS PANEL TO SIT ON TOP OF TUB DECK BATH AND FLUSH W/ INNER EDGE. NO LEDGE. EXHAUST-0 STACKABLE WASHER/DRYE SPACE - WASHER ALWAYS ON LEFT SIDE (23) 18" X 18" ACCESS PANEL LOCATION FOR JACUZZI TUB - OPT'L. IF DASHED 24) LOW WALL - HEIGHT AS NOTED (36" HIGH MIN.) - OPT'L IF INDICATED 'OPT.' REFER TO EXHAUST - 4" PHOLE IN WAL Z Z Z Z WATER CLOSET -PROVIDE MIN. CLEARANCE AS LEFT FOR DRYER VENT DETAILS 7/DI.7 AND 8/DI.7. WASHER / DRYER HANDRAIL/GUARDRAIL - GUARDRAIL 36" MIN REFER TO DETAILS 7/DI.7 THROUGH 12/DI.7 INDICATED - OPT'L IF 26) WROUGHT IRON RAILING - PROVIDE VERTICAL 2x6 SOLID BLOCKING EACH END, SET BACK I 3/4" FROM FACE OF COLUMN OR CORNER MIN. CLEARANCE AS OPTIONAL RAILING I.L.O. LOW WALL - 36" HIGH MIN. - REFER TO DETAILS II/DI.7 AND 12/DI.7 INDICATED - OPT'L IF -----<u>7</u> DASHED URINAL - PROVIDE MIN. CLEARANCE AS (28) FLAT SOFFIT - 8'-1" AT FIRST FLOOR U.N.O. INDICATED - OPT'L IF - 7'-1" AT SECOND FLOOR U.N.O 29 PROVIDE OPTION FOR DOUBLE REFRIG. I.L.O. STANDARD REFRIG. SHOWN - COORDINATE GARAGE ALT. CABINET CONFIGURATION W/ CABINET WATER HEATER ON PLATFORM MANUFACTURER. WATER HEATER — 18" A.F.F. - REFER TO OPTION FOR UNDER COUNTER REFRIG. OR FU SIZE REFRIG. I.L.O. SHELVING IN THIS LOCATI PURCHASING SPEC. FOR MODEL OPT. TANKLESS WATER HEATER -LAVATORY WITH WALL MOUNTED MIRROR TO DRAIN S 31) TRAY CEILING - HEIGHT PER PLAN - OPT'L II REFER TO PURCHASING SPEC. MATCH VANITY LENGTH FOR MODEL (2) OPTIONAL GLASS LOW WALL WITH GUARDRAIL OPT'L IF DASHED PIPE BOLLARD - PROVIDE 3" AND TEMPERED GLASS AT 36" A.F.F. MIN. -DIA. SOLID GROUTED PIPE REFER TO STRUCTURAL AND GUARDRAIL BOLLARD AS NEEDED - REFER CONTRACTOR DRAWINGS FOR DETAILS. MIRROR - HEIGHT PER BUILDER SPEC'S TO PLAN FOR LOCATION 33) Line of Ceiling Change - Height per Plan (34) LINE OF FLOORING CHANGE OPT'L IF DASHED PEDESTAL SINK WITH (35) PROVIDE DRYER MAKEUP AIR SEE DETAIL 16/DI.5 DRAIN E WALL MOUNTED 24"x36" OVAL MIRROR - OPT'L IF DASHED (36) WASHER FREE STANDING UTILITY SINK - OPT'L IF DASHED 1-3/4" SOLID CORE DOOR, TIGHT FITTING, SELF-CLOSING, SELF-LATCHING WITH GASKETS FAUCET 1 1 AND SWEEP - MIRROR - HEIGHT PER BUILDER SPEC'S SERVICE DOOR - OPT'L IF DASHED MECH. / PLUMB. / ELEC. PRE-FAB SHOWER/TUB WITH
ROD FOR SHOWER CURTAIN SHOWER HEAD ROUGH-IN AT
82" A.F.F. U.N.O. - PROVIDE
NONABSORBMENT
CEMENTATIOUS BACKER
PANELS ON WALLS MIN. 72"
ABV DRAIN BER IRC. P3012
ABV DRAIN BER IRC. P3012 (39) CONCRETE STOOP MIN. WIDTH OF DOOR DRAIN HOUSE 10" - ALT. LOCATION IF DASHED 4) TWO 14"M × 8"H HIGH/LOW VENTS AT +4" ABOVE STEM AND -4" BELOW CEILING @ GAS COMMUNITIES ONLY MECH. UNIT -MECHANICAL UNIT -LOCATE AND INSTALL PER MECHANICAL PLANS ABV. DRAIN PER IRC R301. \$ R702.4.2. 2) EXTERIOR SOFFIT - REFER TO ELEVATIONS PRE-FAB SHOWER WITH TEMPERED GLASS DOOR -PROVIDE NONABSORBMENT HIS I/2" EXTERIOR RATED, SAG RESISTENT GYP. BD. AT PATIO/PORCH CEILING ICC ESR-1338 5'-0"x10'-0" PLATFORM ATTIC - LOCATE PER CEMENTATIOUS BACKER MECH. PLATFORM MECHANICAL PLANS 4) 5/8" TYP. 'X' GYP. BD. AT USEABLE AREAS UNDER STAIRS, BEARING WALLS, AND GARAGE PANELS ON WALLS MIN. 72 ABV. DRAIN PER IRC R301. ELECTRICAL PANEL LOCATE PER UTILITY COMPANY - VERIFY & R702.4.2. - OPT'L IF TEMP. GLASS DOOR 45) 1/8" SLOPE PER 1'-0" LOCATION PER CITY -ALT. LOCATION IF DASHED SHOWER HEAD ROUGH-IN AT 84" A.F.F. U.N.O. (46) 1/4" SLOPE PER 1'-0" 47) MECHANICAL CHASE GAS METER - LOCATE PER UTILITY COMPANY -VERIFY LOCATION PER CITY - ALT. LOCATION IF STANDARD PRE-FAB (48) FIREBLOCK ALL VOIDS - TYP. SLIDE-IN TUB: (49) T&P RELIEF VALVE AT +6" MAX ABOVE FLOO A= 60", B= 42" AND C= 16" OPTIONAL GARDEN TUB DROP-IN - TUB DECK SIZE: OR WASTE RECEPTOR TEMPERED GLASS A= 66". B= 46" AND C= 20 PROVIDE NONABSORBMENT SLOPE SHELF FOR POSITIVE DRAINAGE -PROVIDE THERMOPLASTIC WATER- PROOFING BACK FLOW PREVENTER CEMENTATIOUS BACKER AND SHUT OFF VALVE AT FRONT LOCATION - ALT. LOCATION IF DASHED PANELS ON WALLS MIN. 72 MEMBRANE OR EQUAL UNDER STUCCO (UES ABV. DRAIN PER IRC R301. \$ R102.4.2. 2) GAS SHUT OFF VALVE @ GAS COMMUNITIES ONLY. - OPT'L. IF DASHED **MISCELLANEOUS** FREESTANDING TUB - REFER TO PURCHASING SPEC. FOR MODEL - DRAIN PER IRC R301.2 & RT02.4.2. (53) DIRECT VENT OR B-VENT GAS FIREPLACE. REFER TO SHEET A4.2 - SHALL BE TESTED IN ACCORDANCE WITH UL 127. - OPT'L. IF DASHED 30x22 ATTIC SCUTTLE -LOCATED PER PLAN 54) FIREPLACE GAS VALVES SHALL BE LOCATED OUTSIDE OF REQUIRED HEARTH AREA, BUT NO MORE THAN 12 INCHES FROM GAS OUTLET. **GENERAL NOTES** 55) 6x6 ROUGH SAWN STRUCTURAL POST AND/OR WALL DIMENSIONS TO BE 3 I/2" FOR 2X4 STUD WALLS OR 5 I/2" FOR 2X6 STUD WALLS REFERENCED TO WALL LEGEND BELOW U.N.O. MEDIA WALL - REFER TO SHEET A4.2 - OPT HEADER HEIGHTS AT ALL FIRST LEVEL WINDOWS TO BE 8'-0" U.N.O. STONE / BRICK VENEER- REFER TO ELEVATIONS HEADER HEIGHTS AT ALL SECOND LEVEL WINDOWS TO BE 7'-O" U.N.O. GLASS IN HAZARDOUS AREAS AND ALL GLASS IB" OR UNDER FIN. FLR. AND WITHIN 24" OF ANY EXTERIOR DOOR SHALL BE TEMPERED SAFETY GLASS. PROVIDE DEPRESSED SLAB FOR OPTIONAL PAVERS PROVIDE PRESSURE BALANCE OR THERMO MIXING VALVE TYP. CONTROL VALVES FOR ALL SHOWER AND TUB COMBOS. GLAZING - ALL WINDOWS AND EXTERIOR DOORS TO BE DUAL GLAZED. ALL INTERIOR DOORS TO BE HOLLOW CORE U.N.O. 3'-0" CONC. SIDEWALK TO REMAIN A MINIMUM I'-0" FROM GARAGE CORNER TO EDGE OF SIDEWALK @ ALL GARAGE EXTENSION OPTIONS. GATE AND HARDWARE IN THE EXIT SYSTEM TO PUBLIC WAY SHALL BE INSTALLED PRIOR TO FINAL INSPECTION AND IN COMPLIANCE WITH IRC. NOTE: ROUGH FRAMING AT ALL DOOR JAMBS TO BE A MINIMUM OF 4" TYPICAL U.N.O. WALL LEGEND 2X4 FRAMED WALL ALL OPTIONAL BELOW MULLED WINDOWS ARE TO BE PROVIDED WITH TEMPERED GLAZING PER CODE REQUIREMENTS. 2X6 FRAMED WALL 2X8 FRAMED WALL

SOLARA 35' SERIES




MAIN LEVEL PARTIAL NOTED FLOO ELEVATIONS 'J' AND 'D'

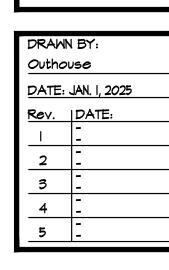

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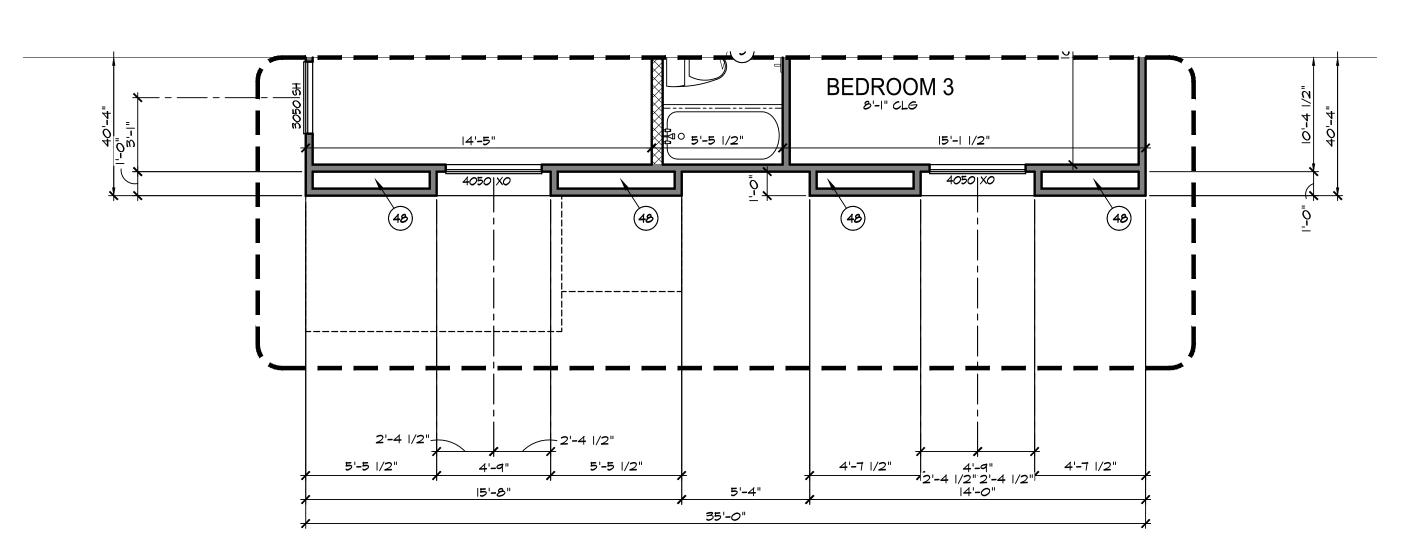
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SECOND LEVEL NOTED FLOOR PLAN - (1298 SQ. FT. LIVABLE) SCALE: 1/4" = 1'-0"

ALL INTERIOR DOORS TO BE 6'-8" U.N.O.

ELEVATION 'J

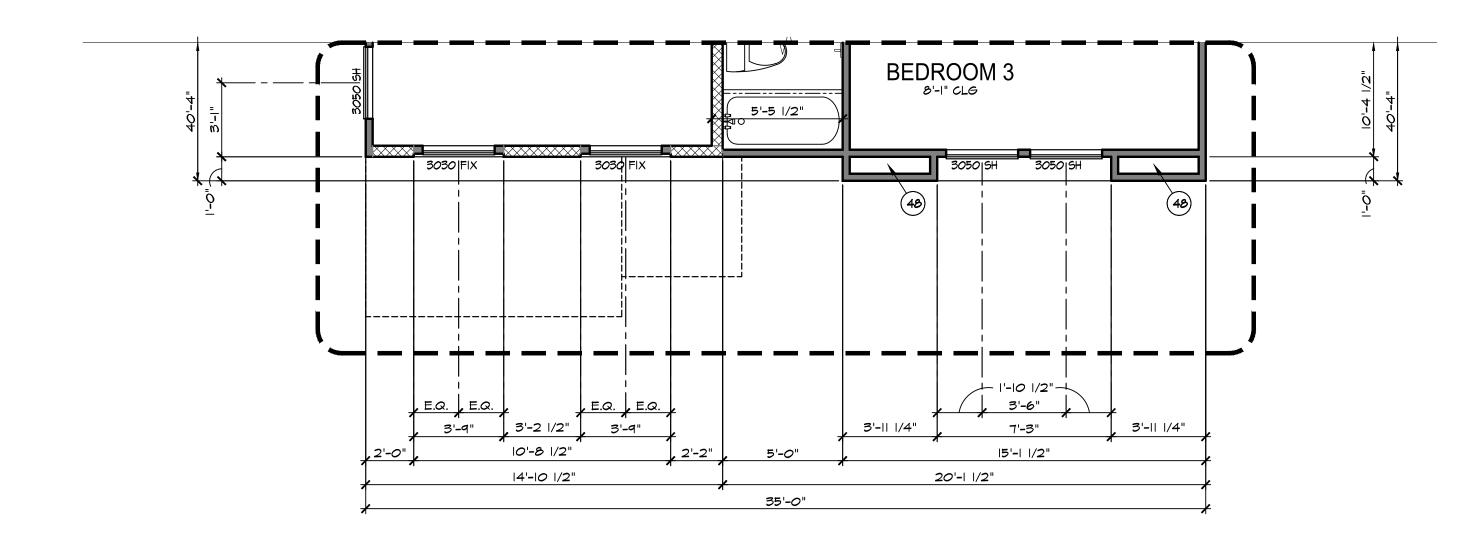


Proposed Conceptual Floor Plans

SECOND LEVEL NOTED FLOOR PLAN - (1298 SQ. FT. LIVABLE) SCALE: 1/4" = 1'-0"

ALL INTERIOR DOORS TO BE 6'-8" U.N.O.

ELEVATION 'D'

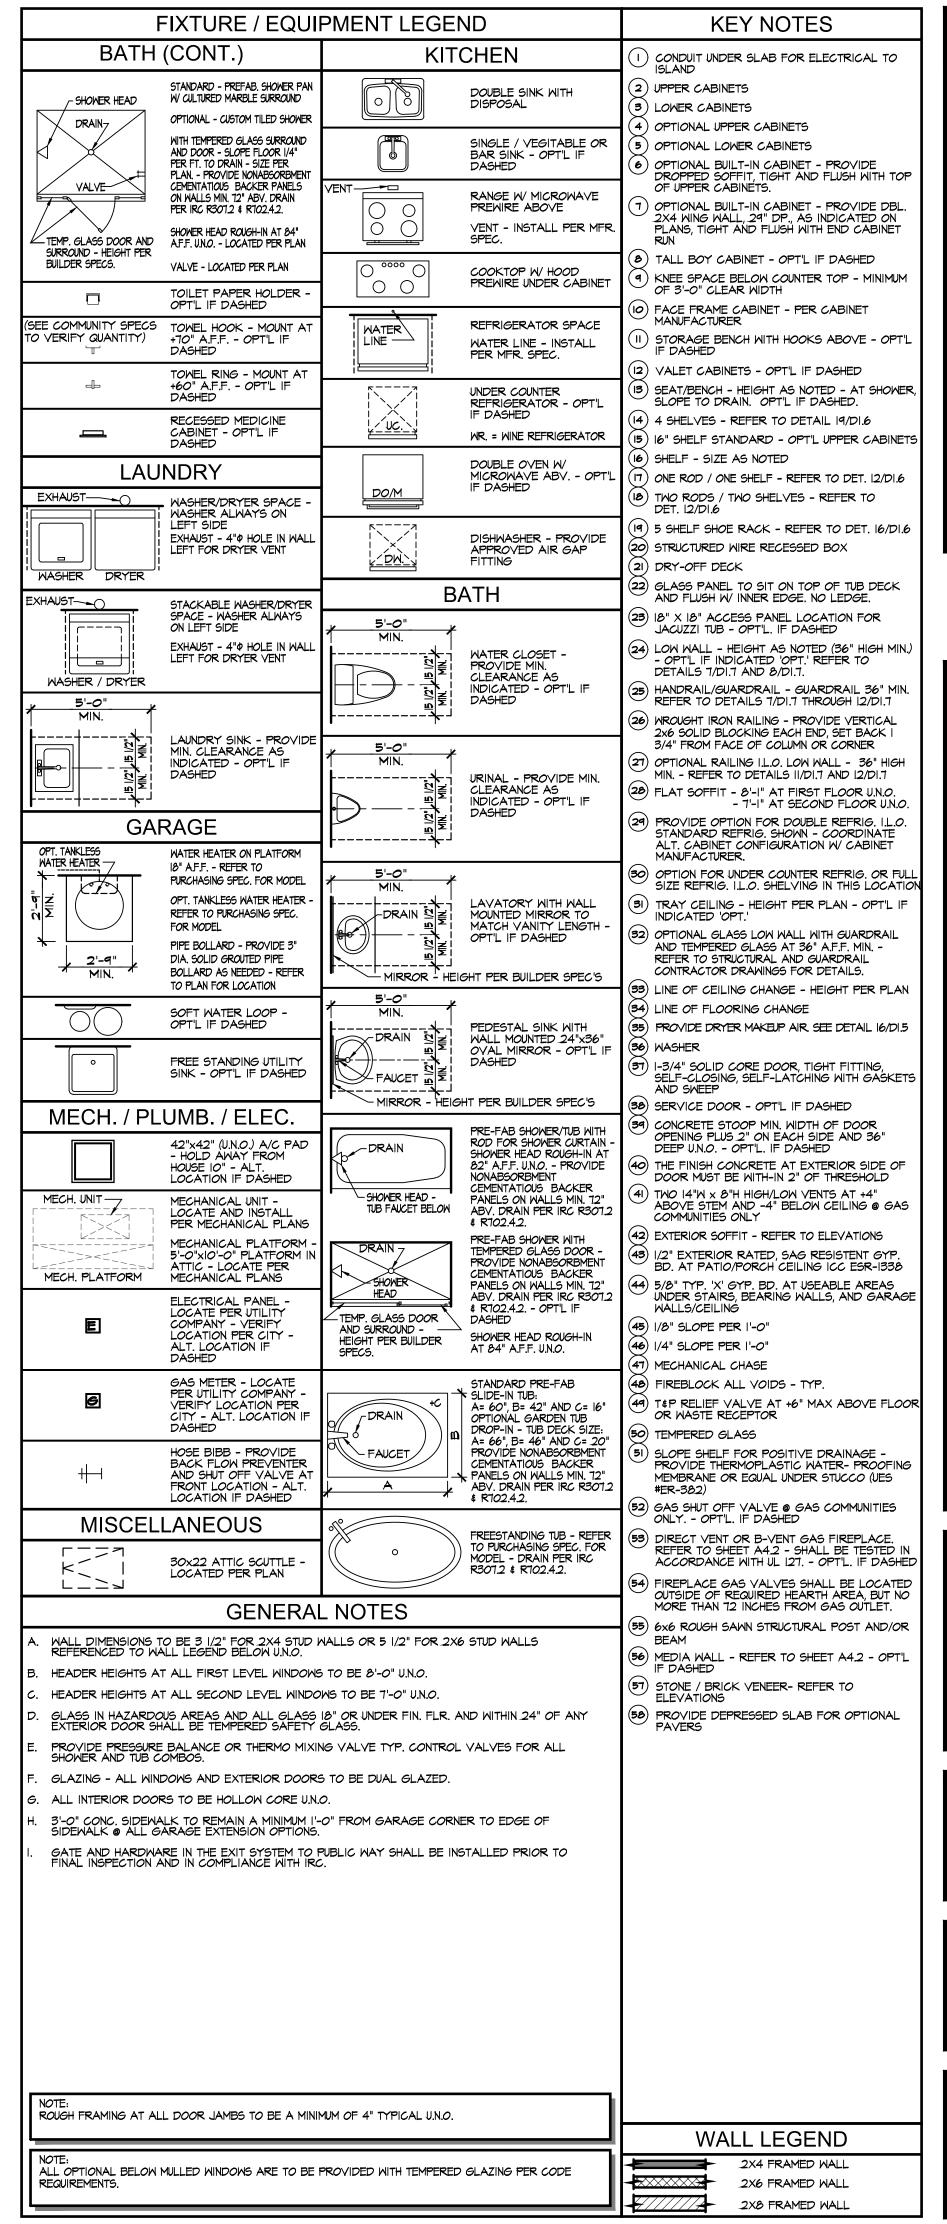

PHO-1-25--Z-12-22-7

April 16, 2025

SHEET No.

SUBDIVISION

35' SERIES

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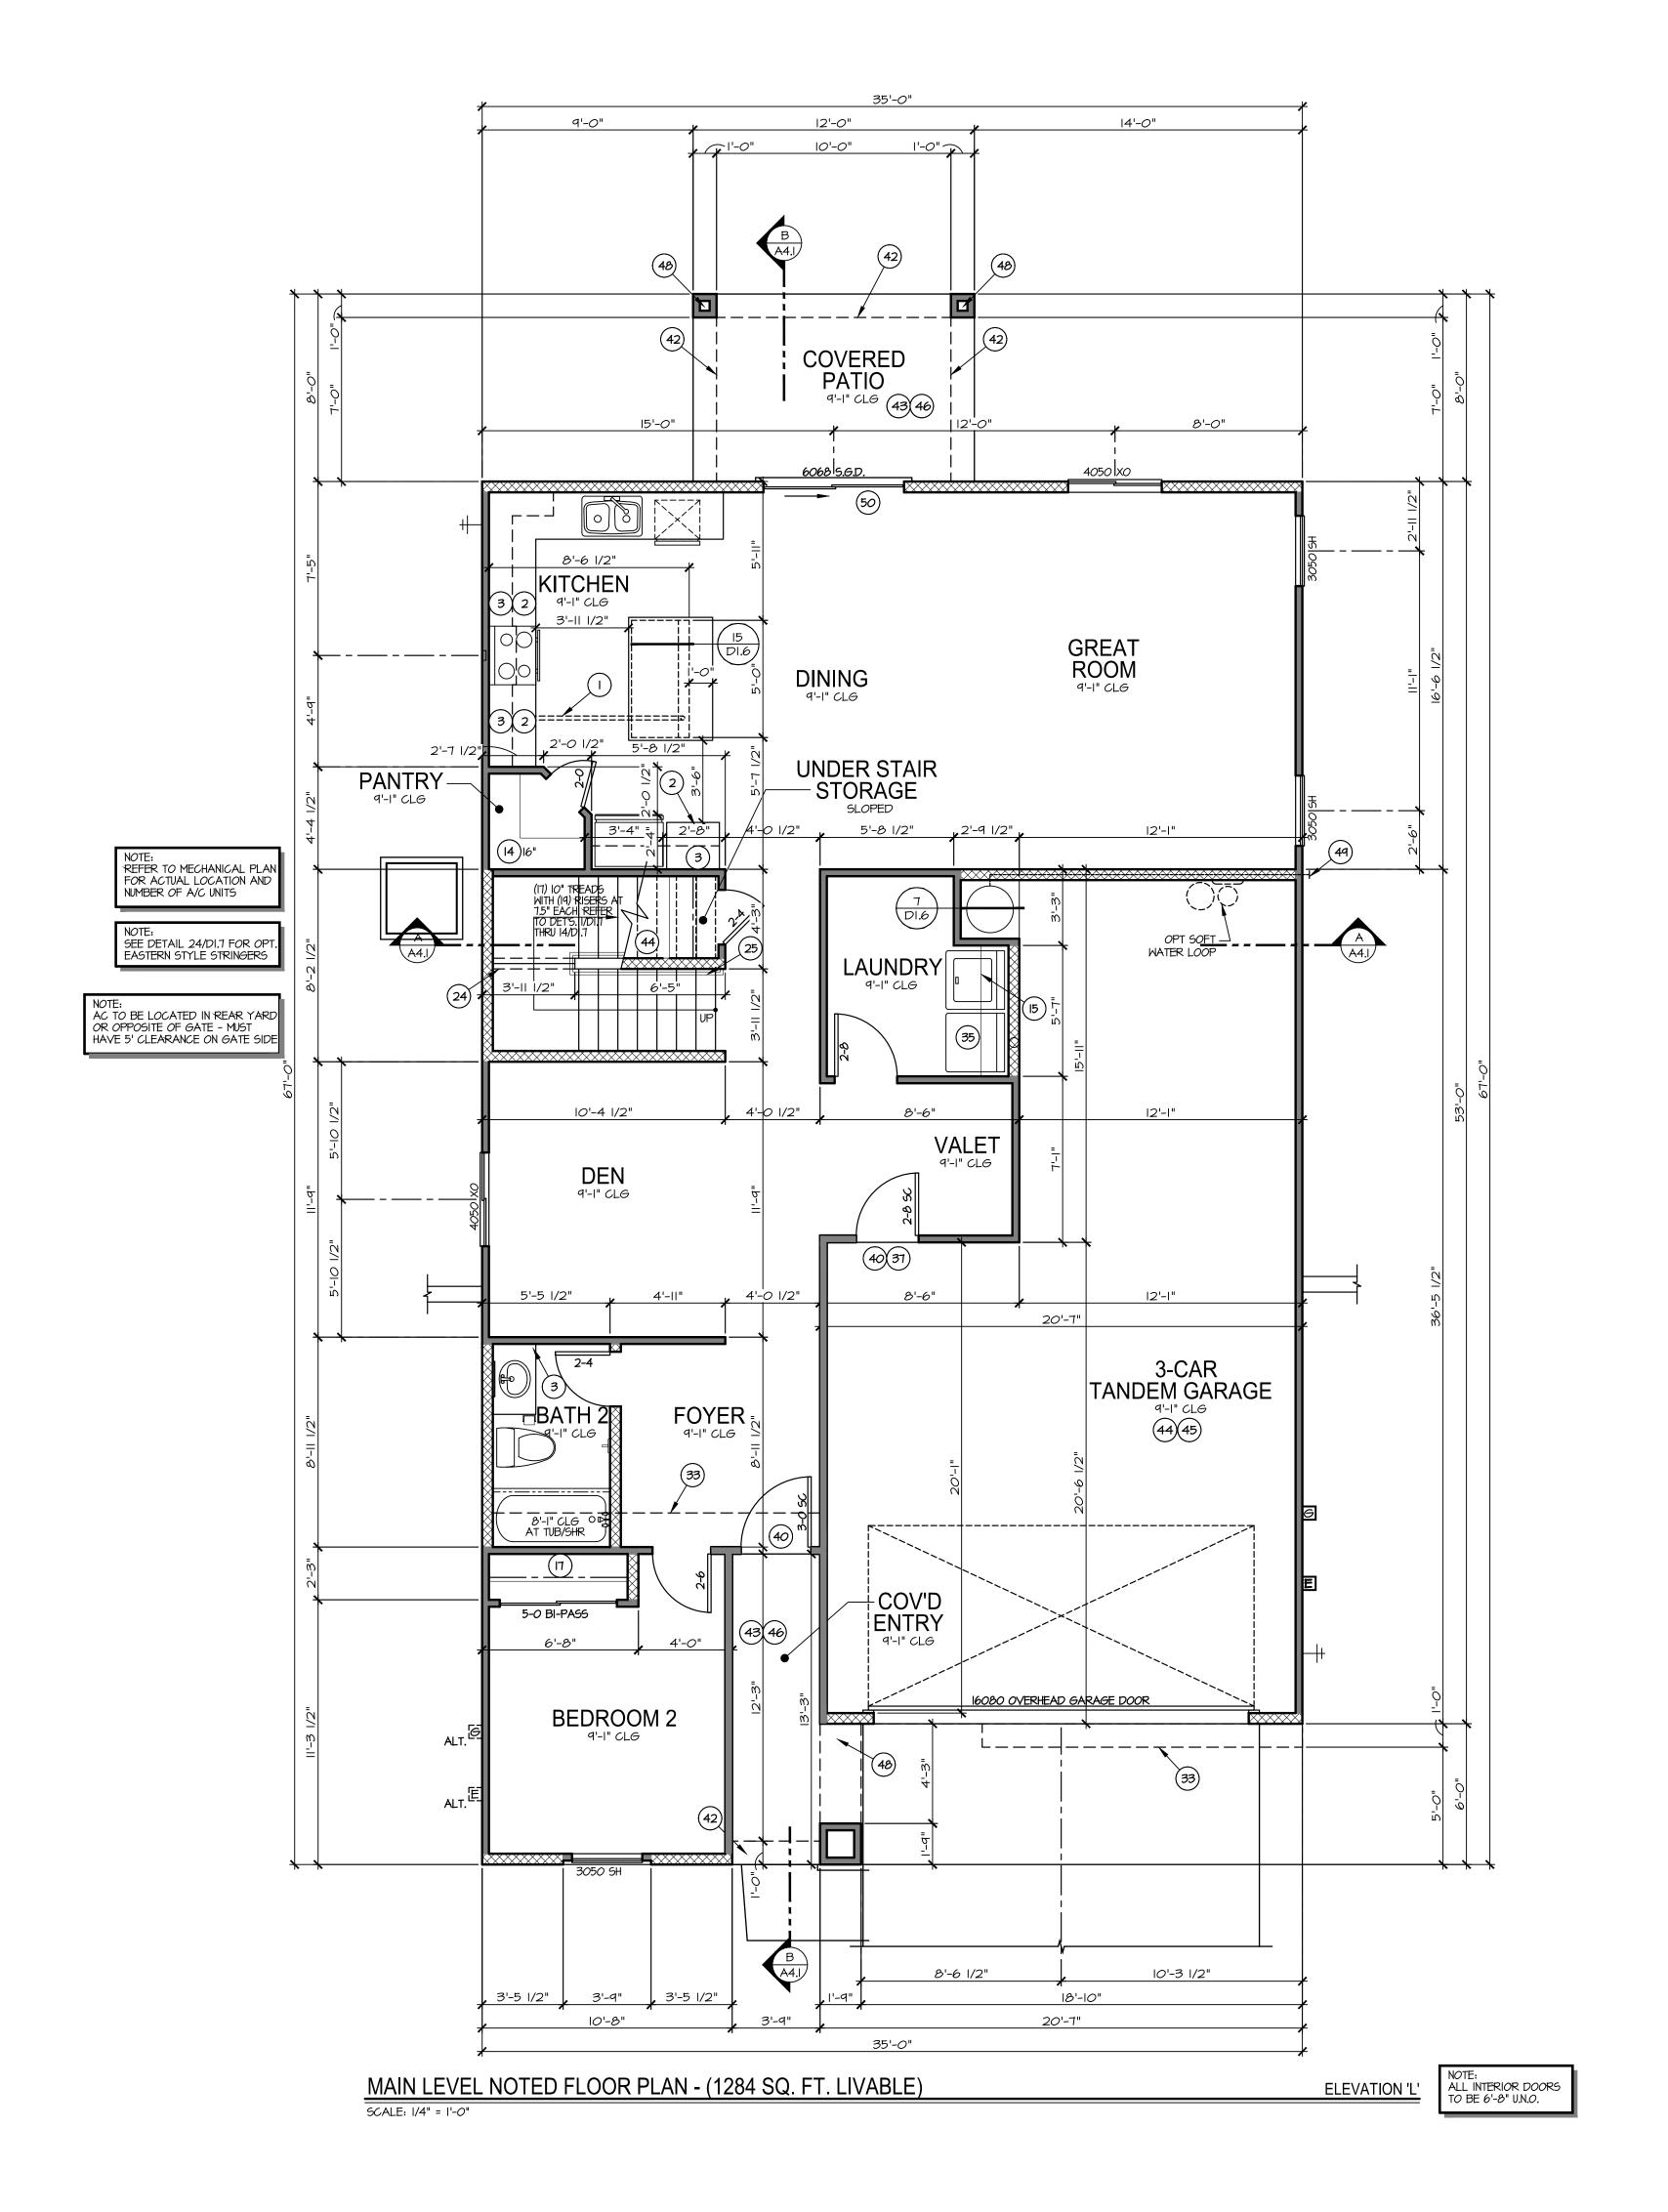
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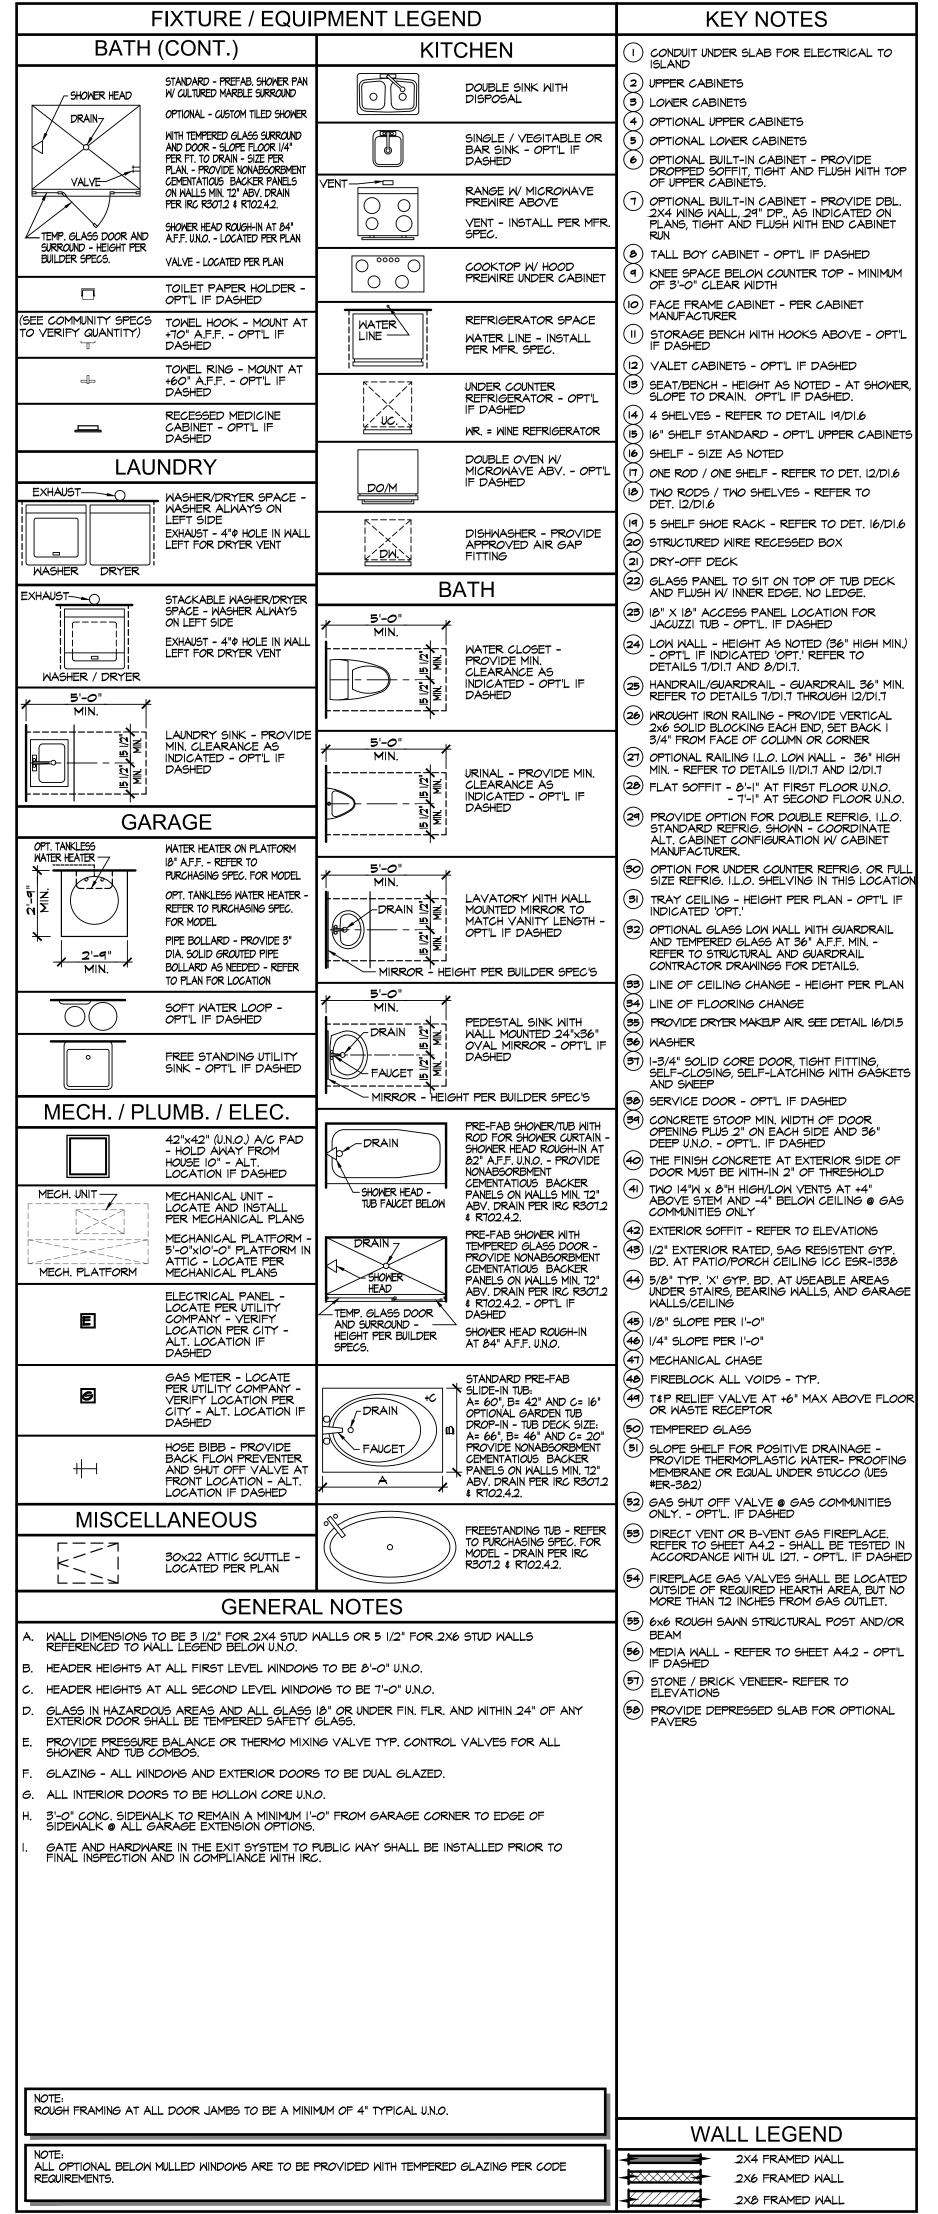
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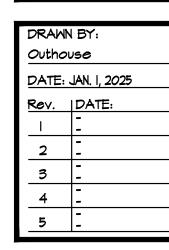






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D





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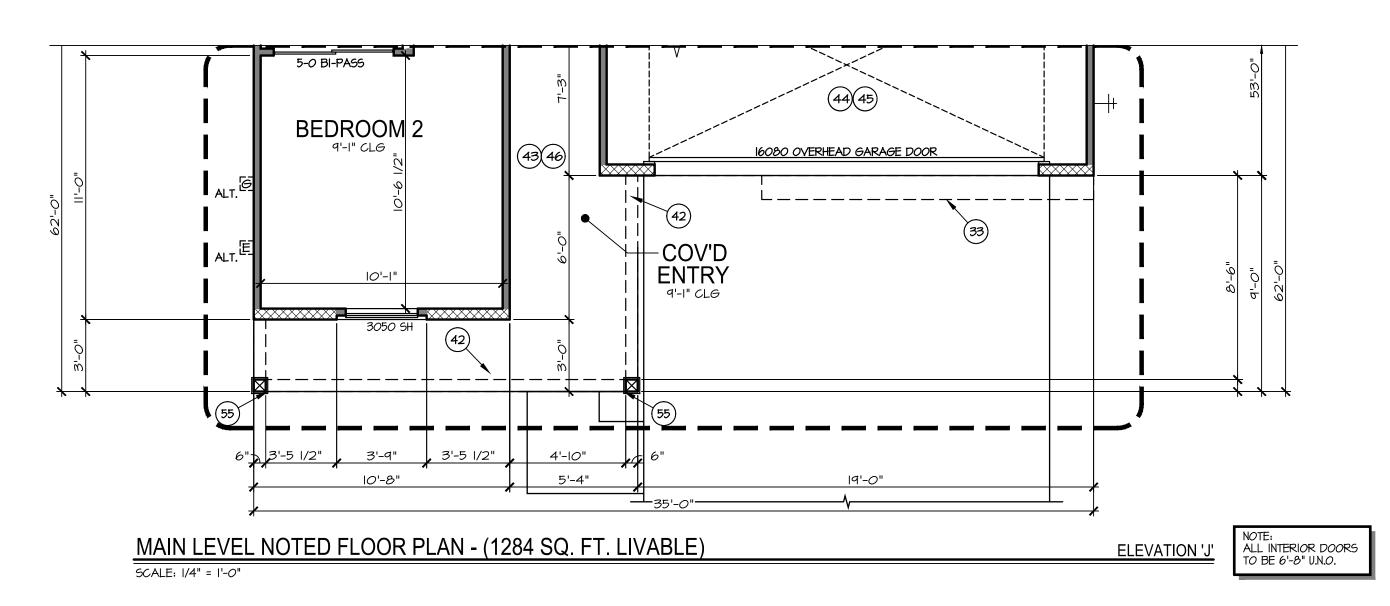
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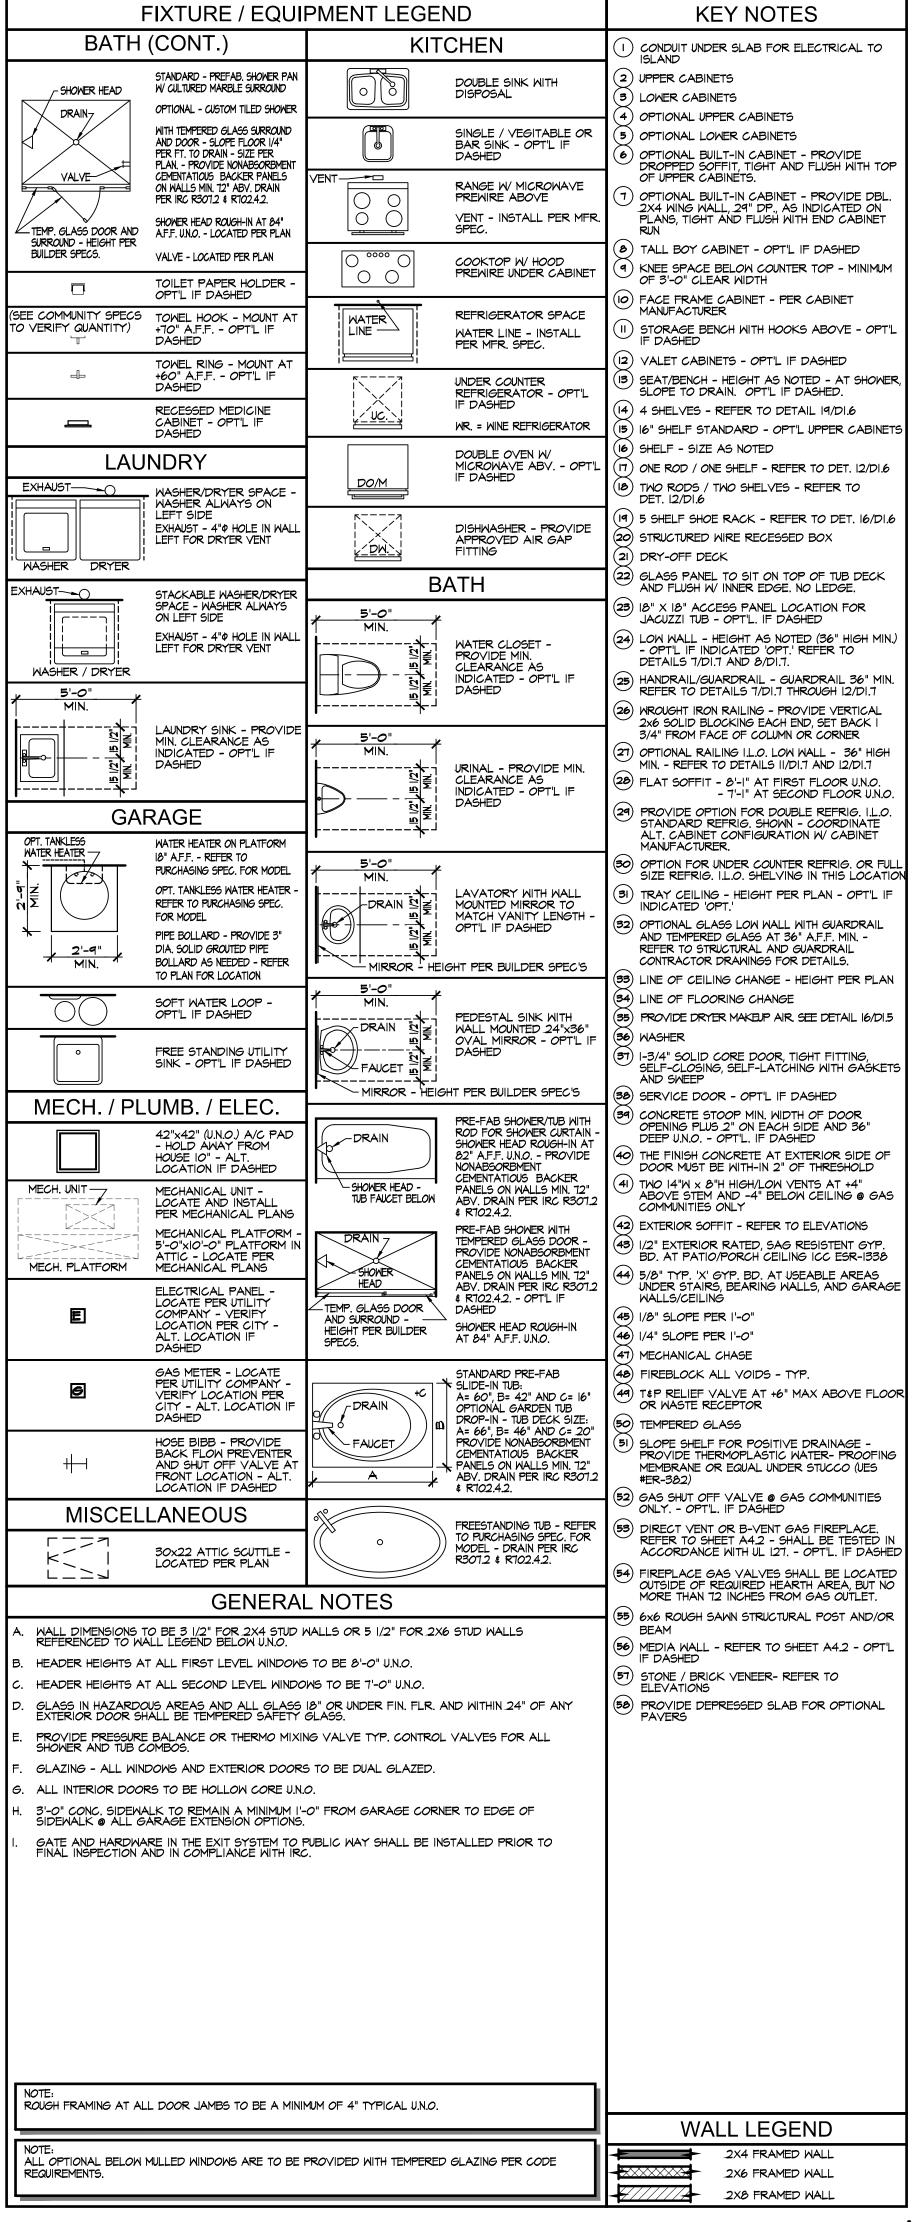
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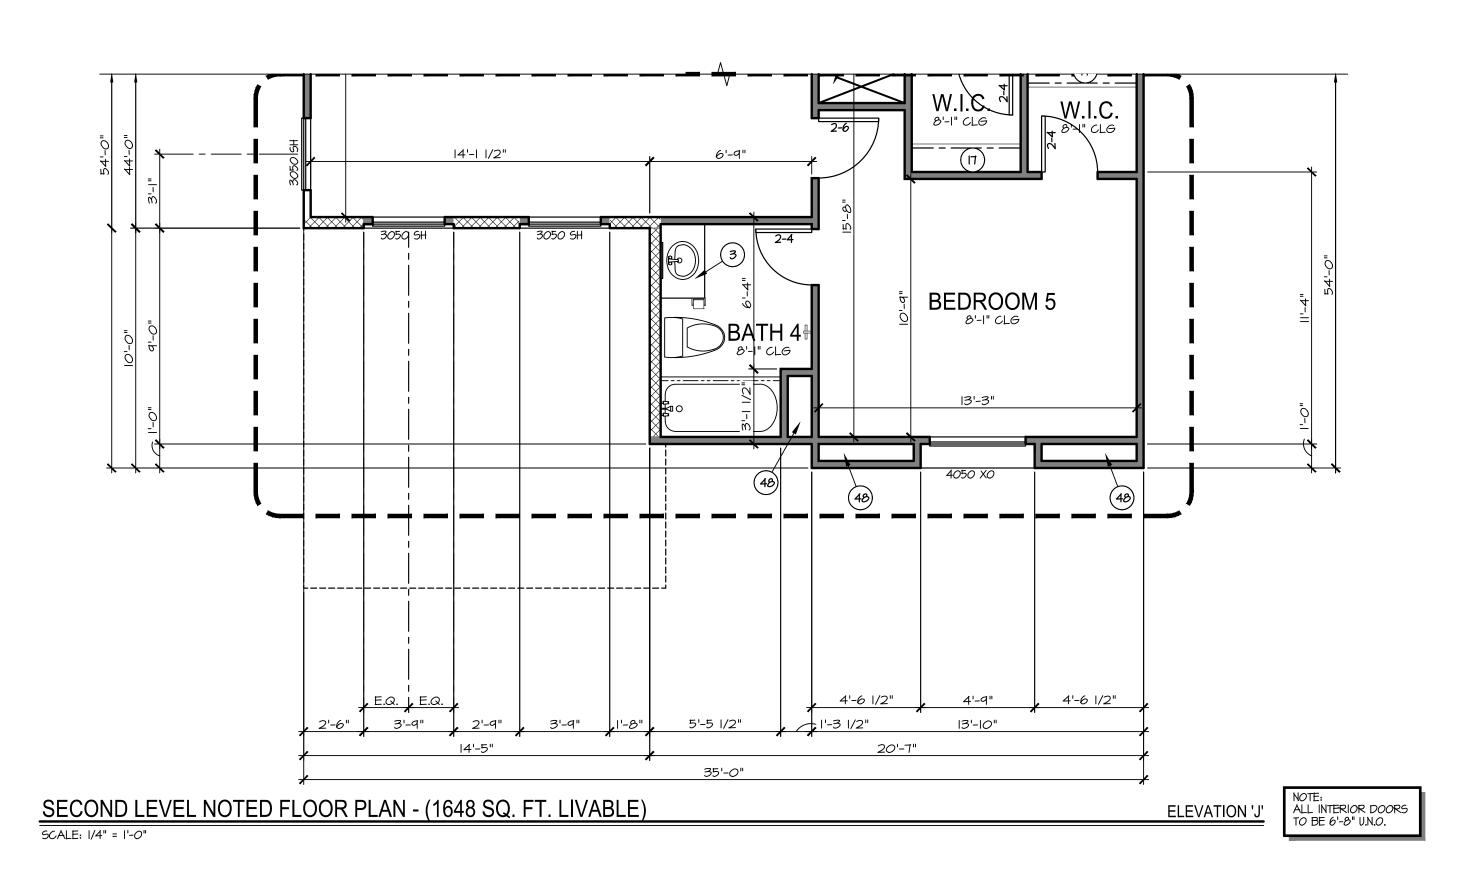
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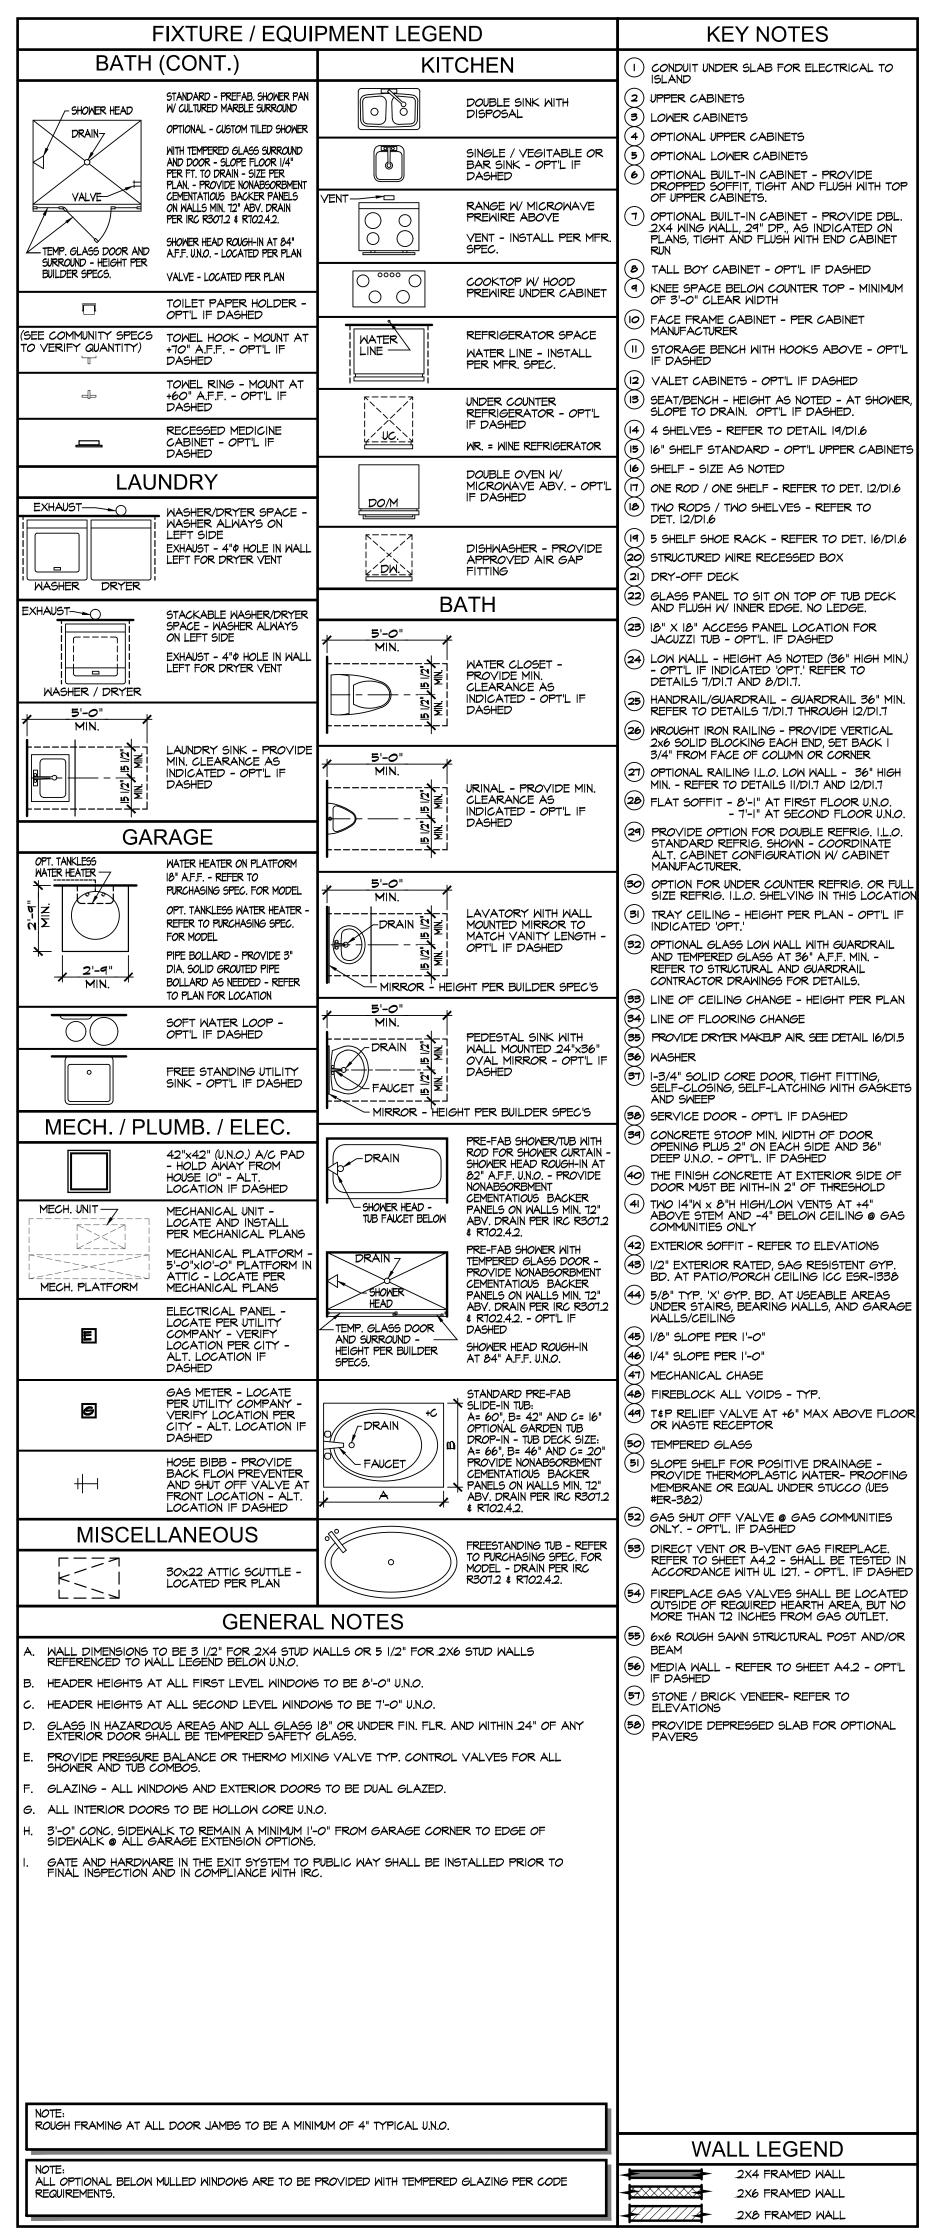
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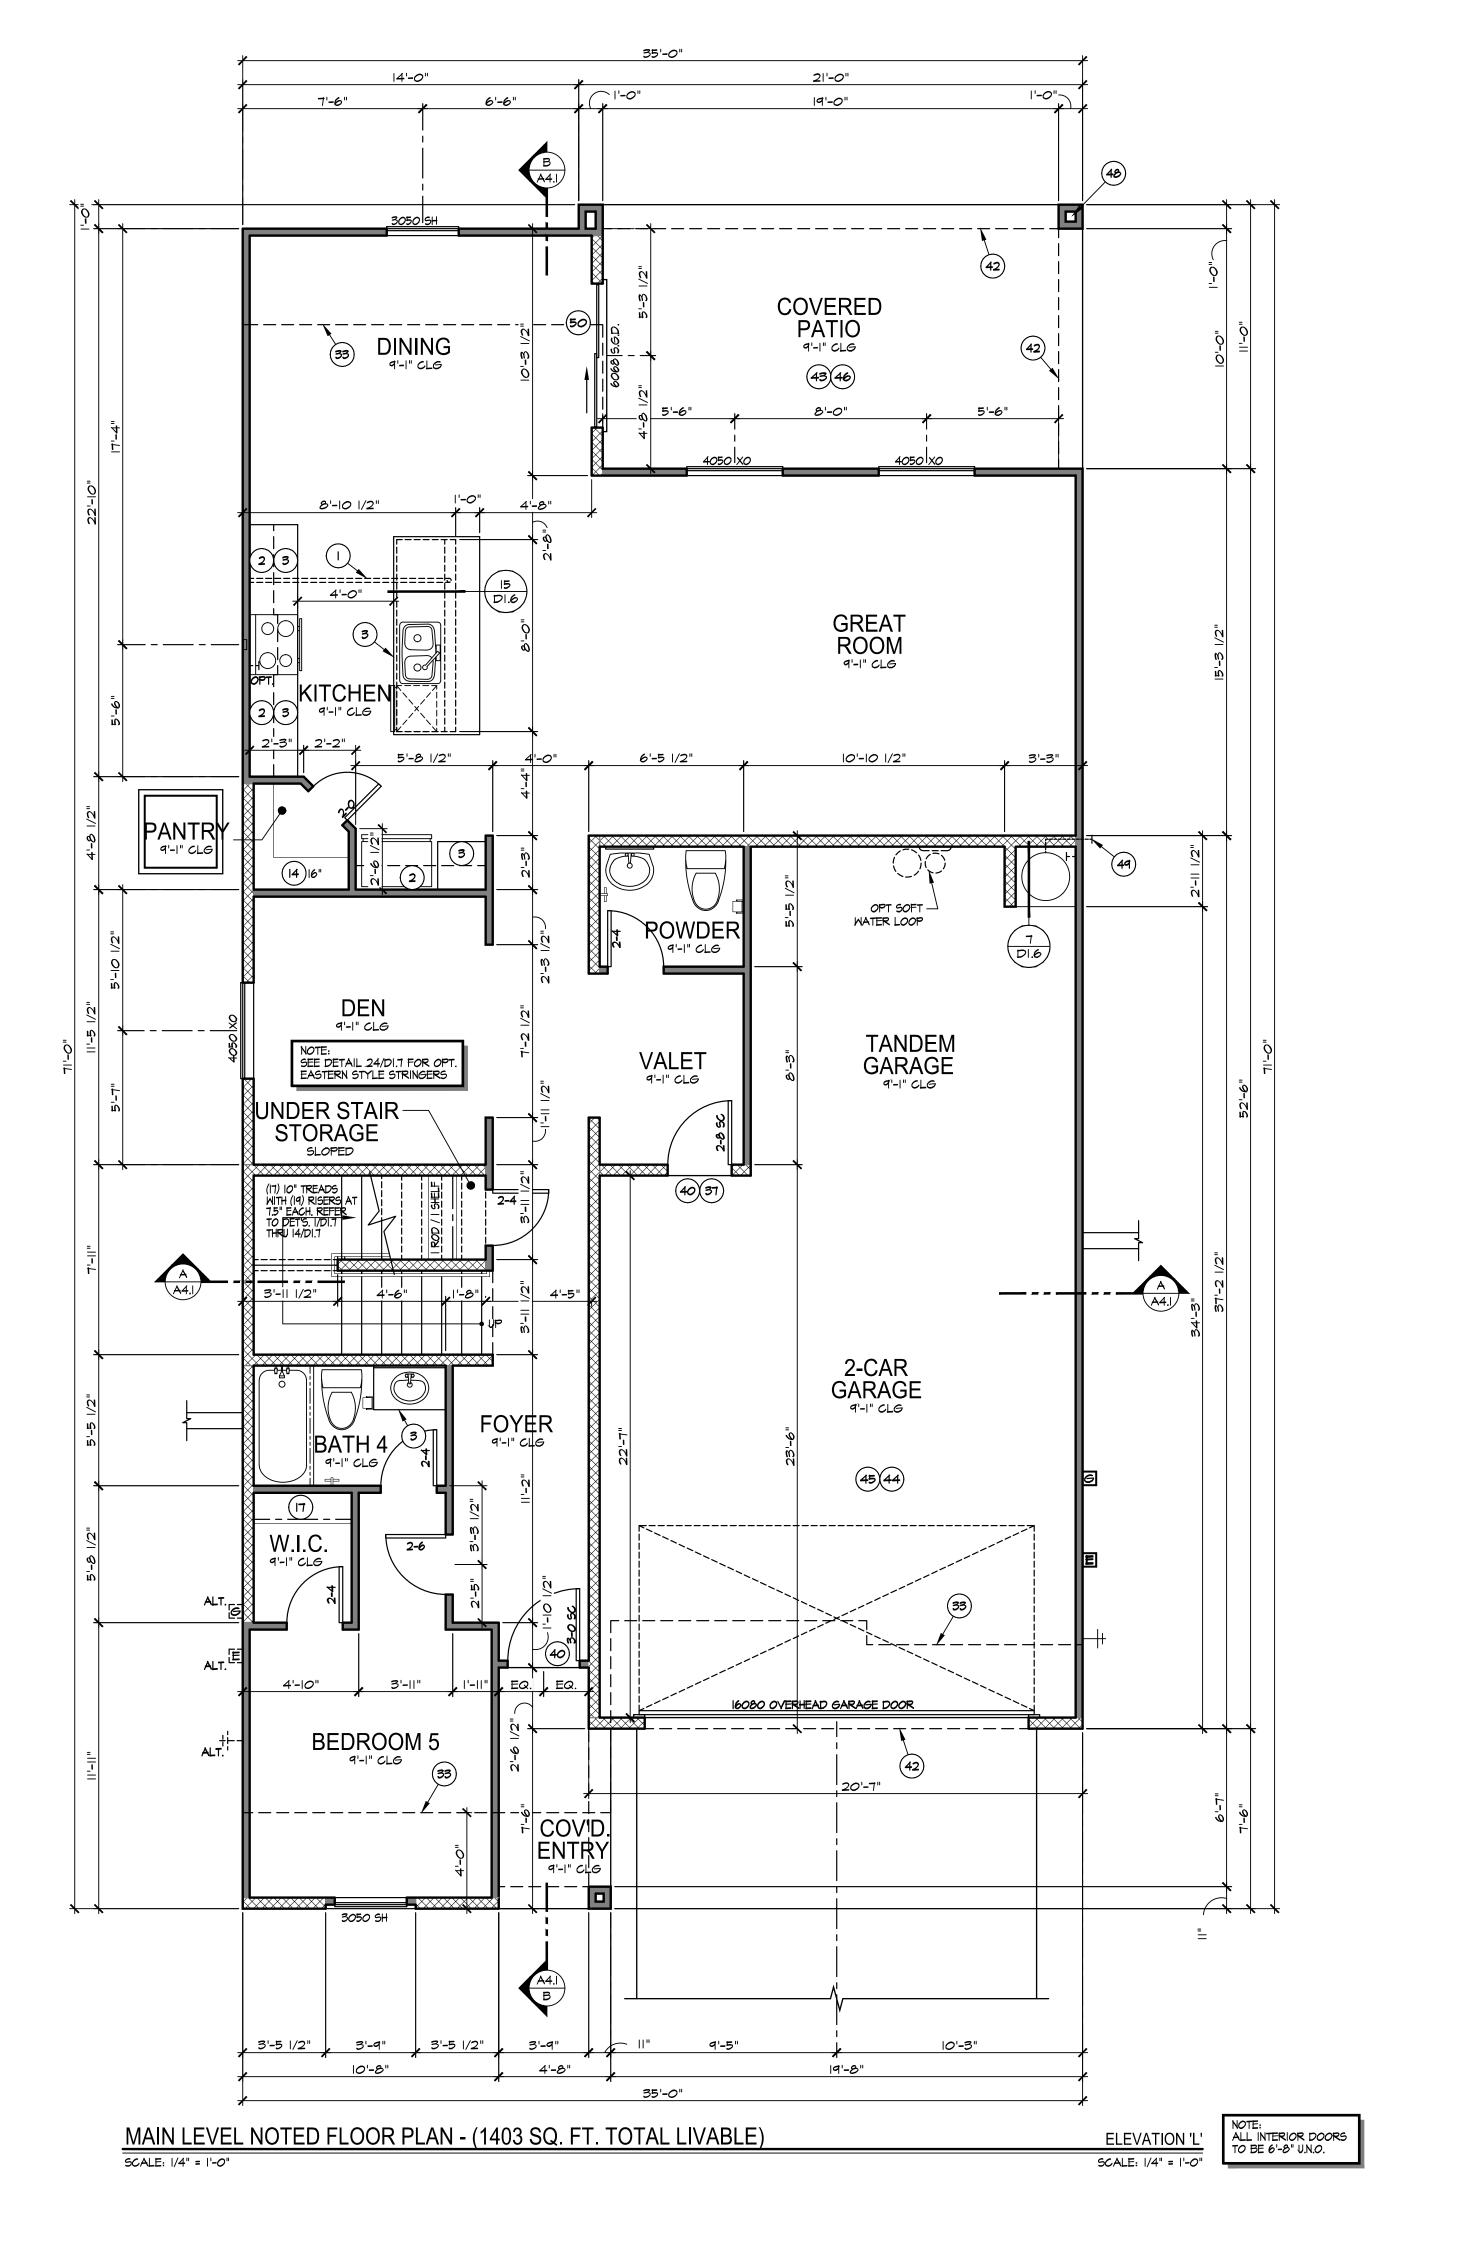
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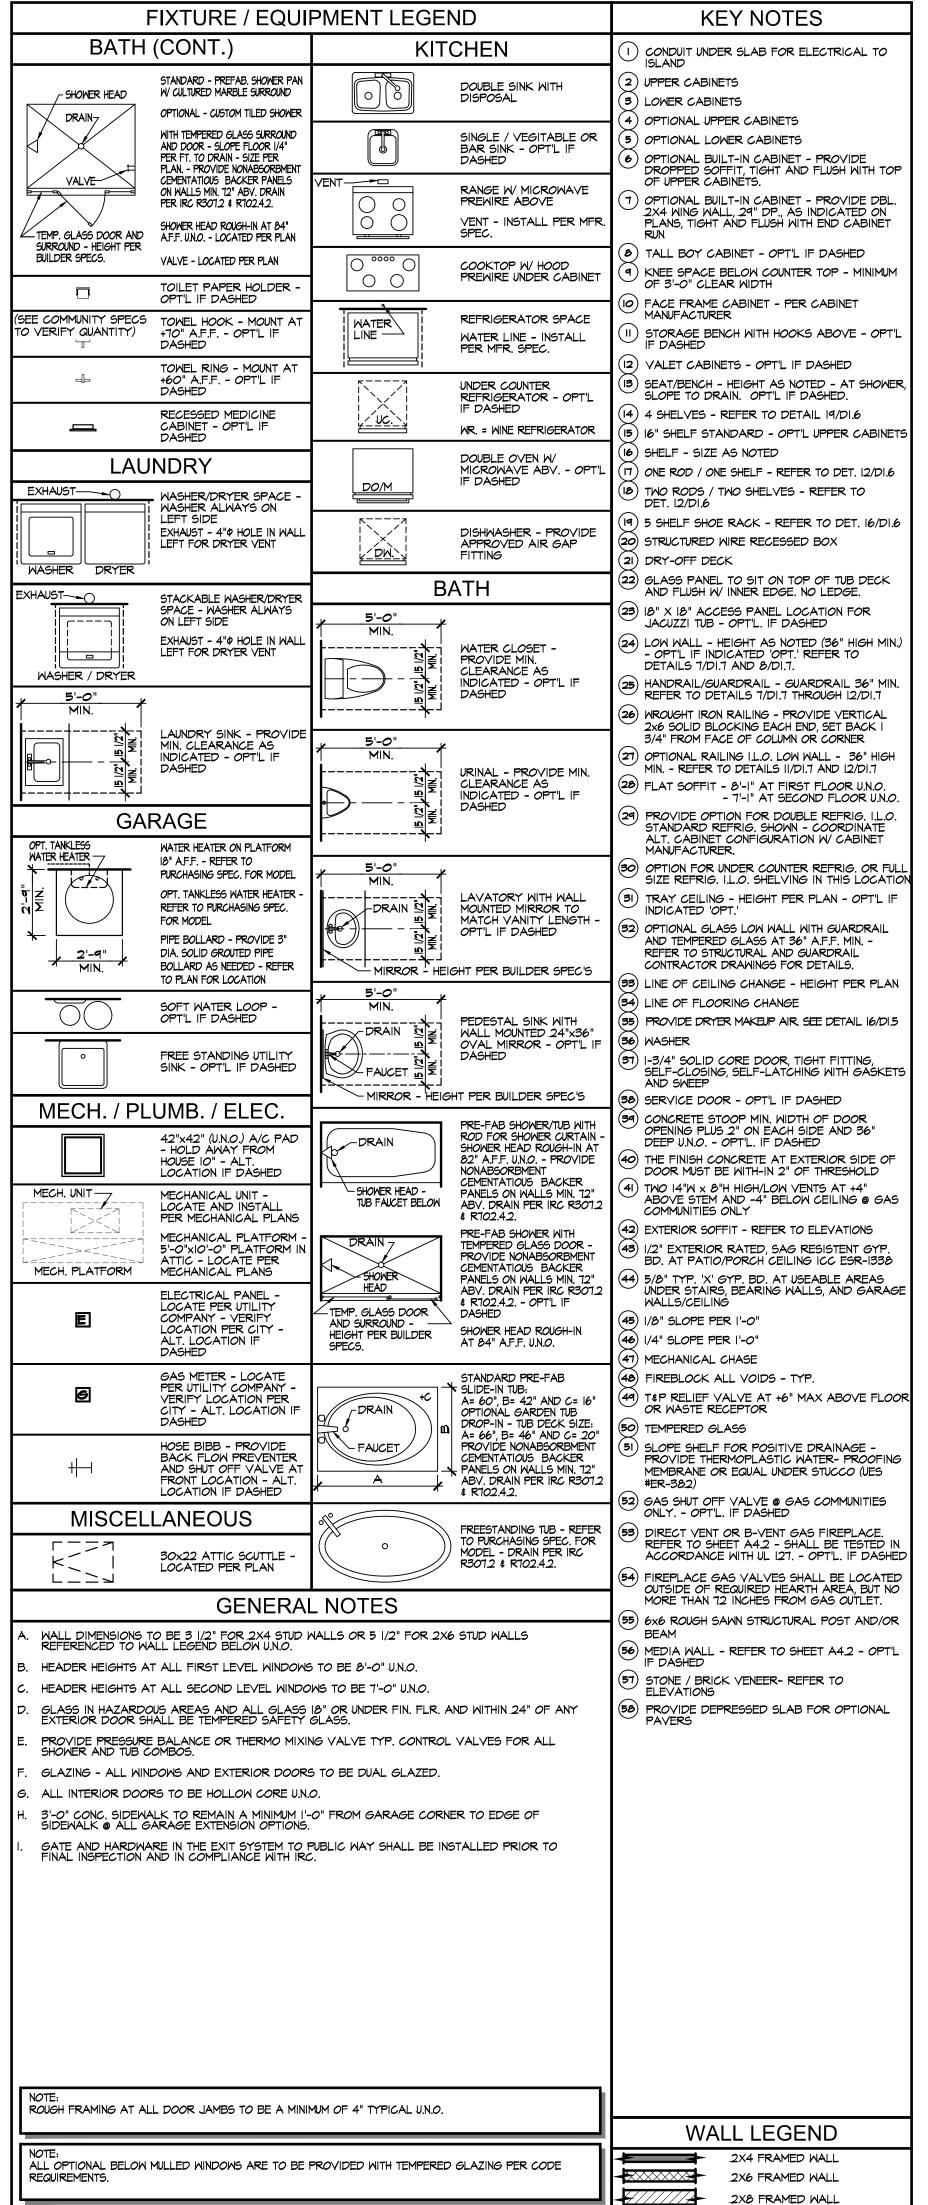
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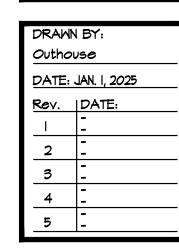
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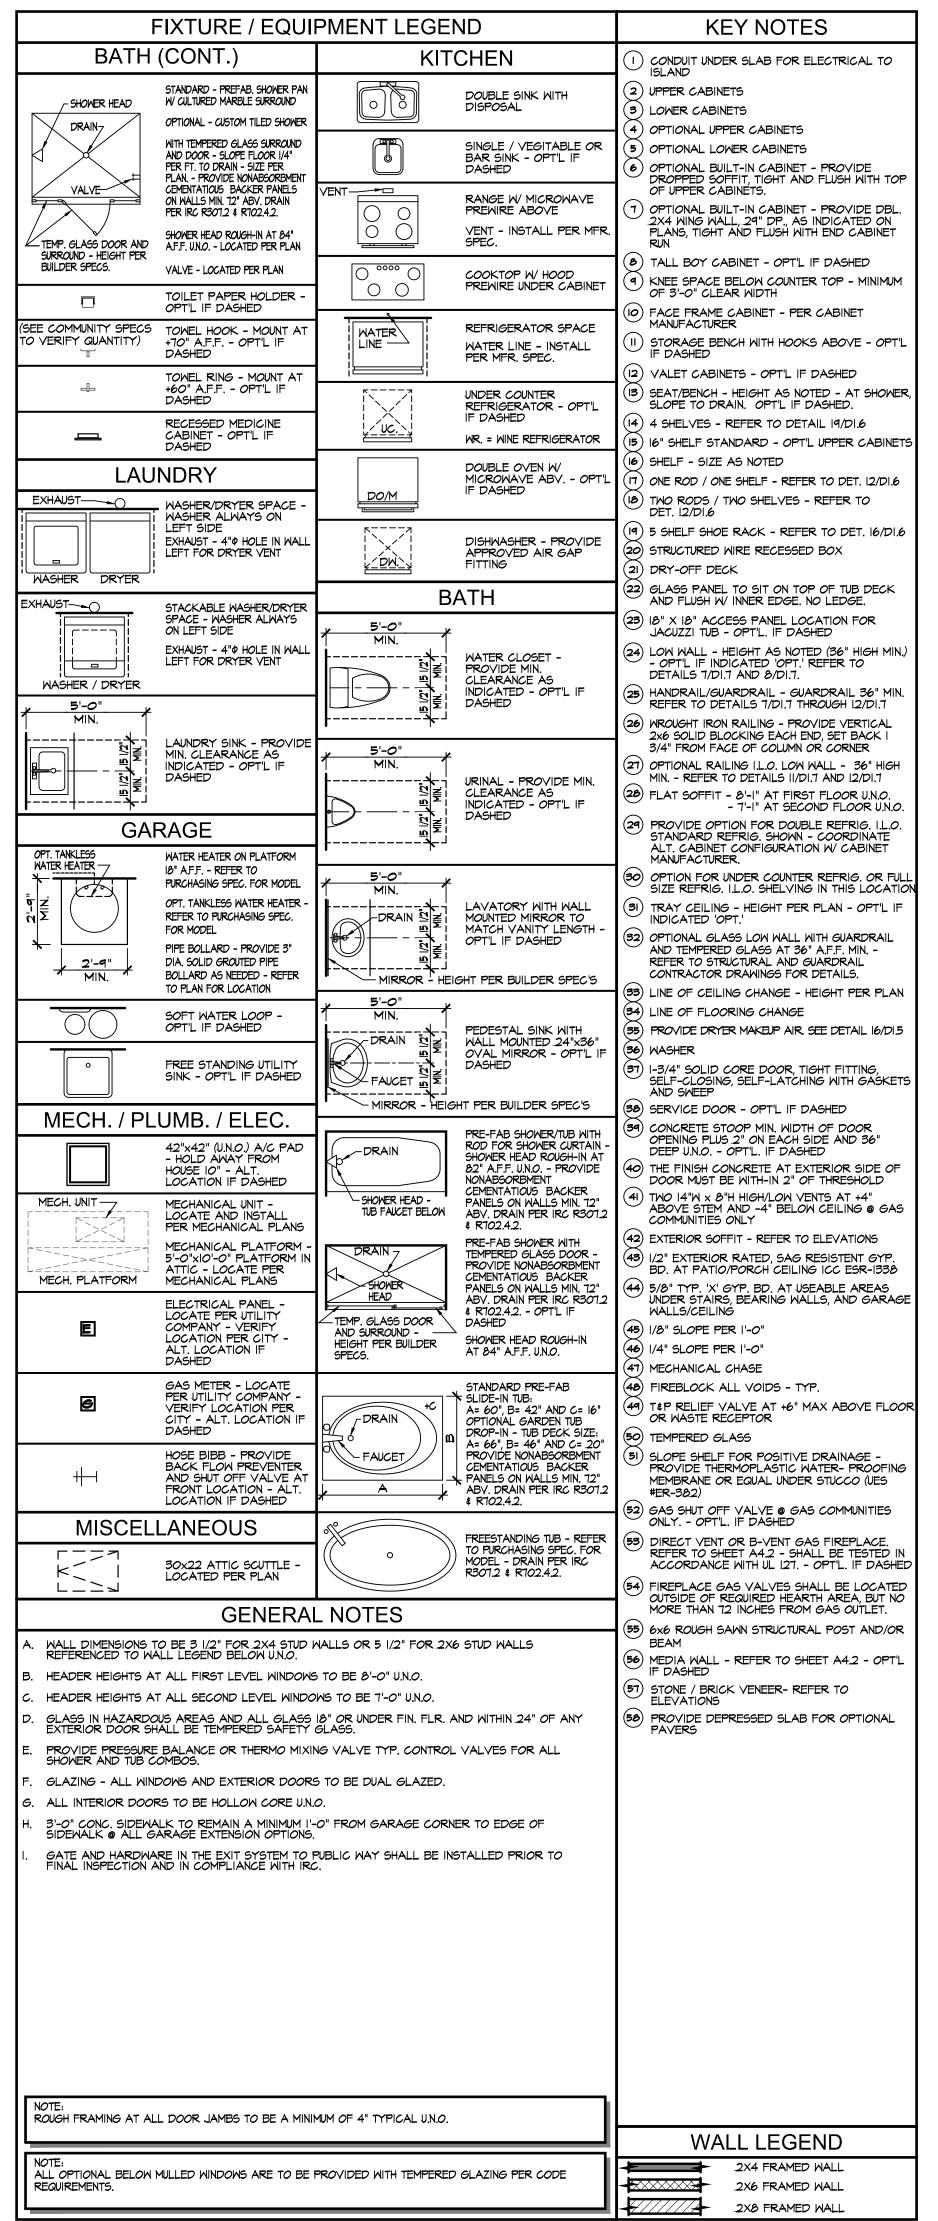
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PLAN# 3560



SHEET No.



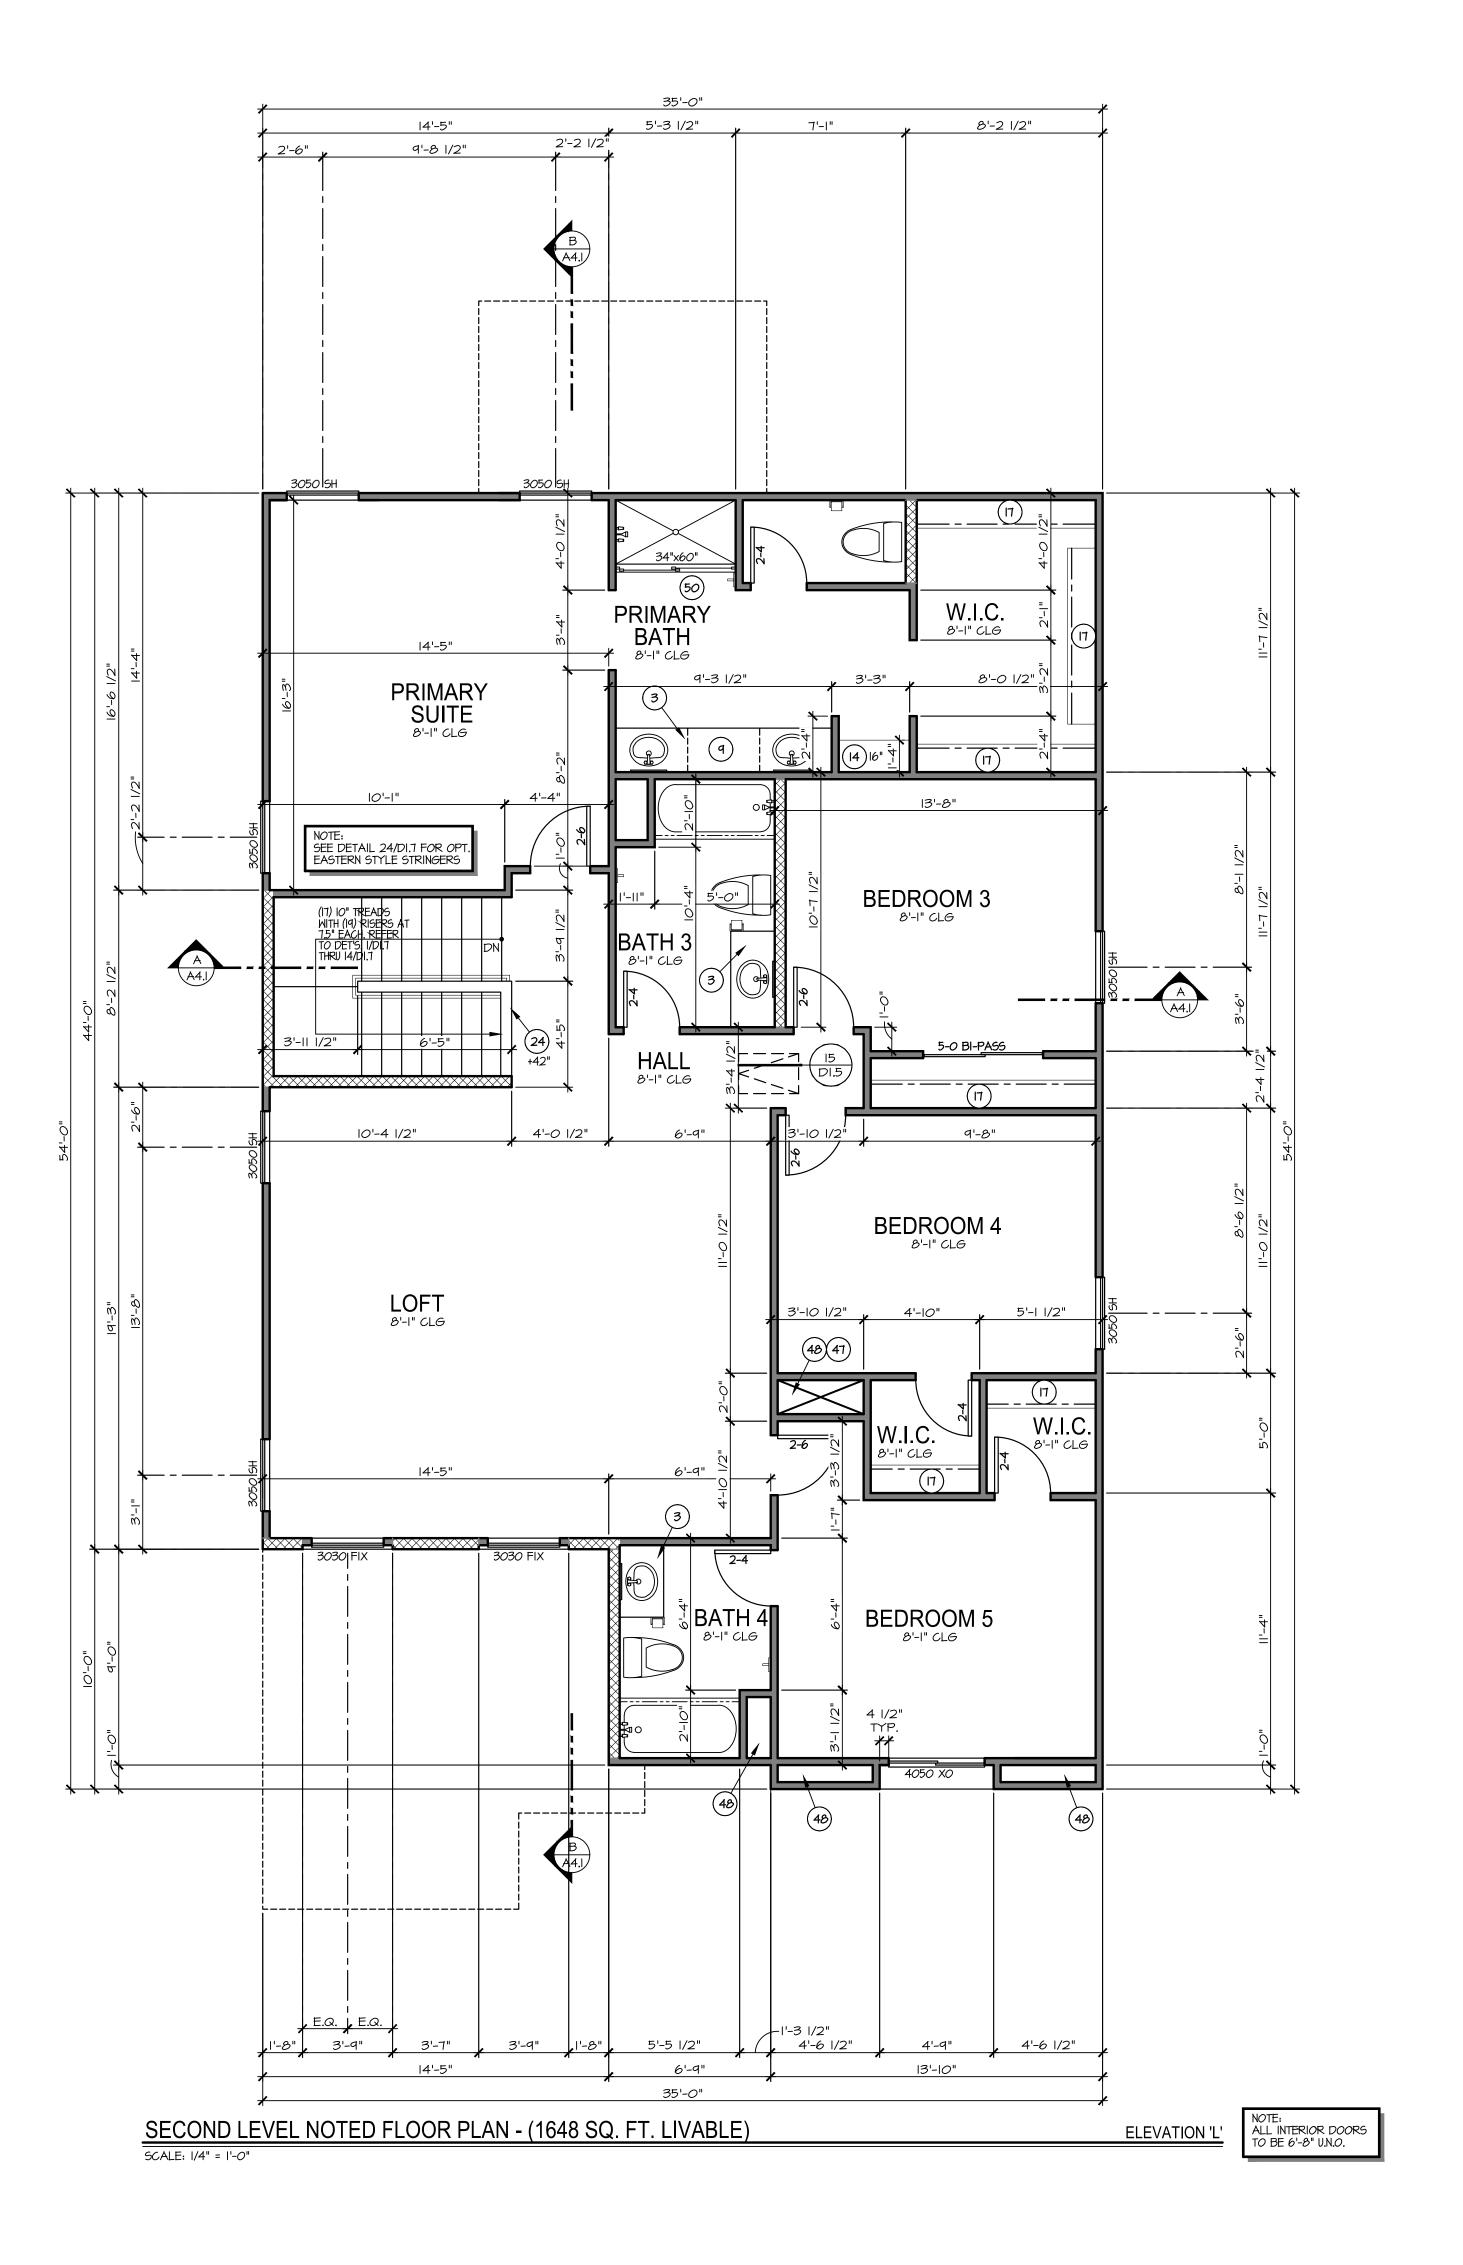
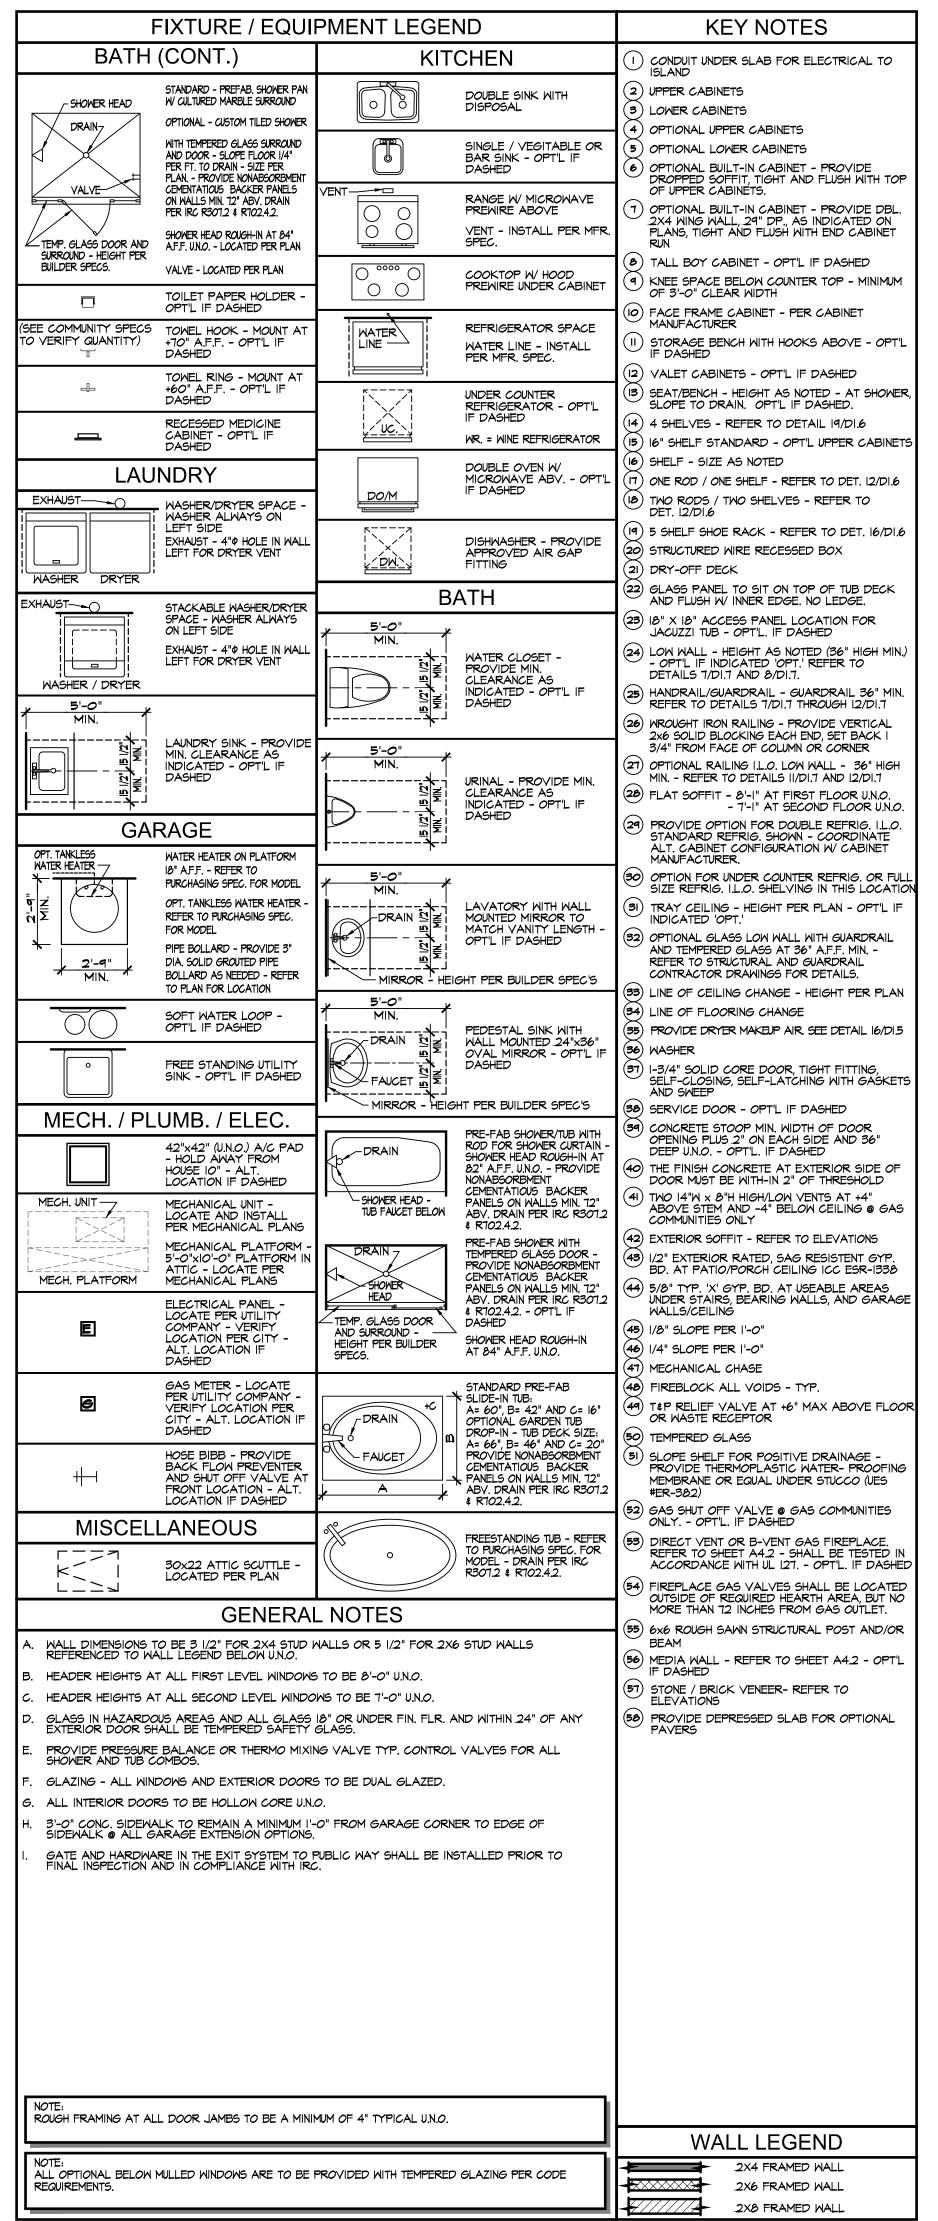
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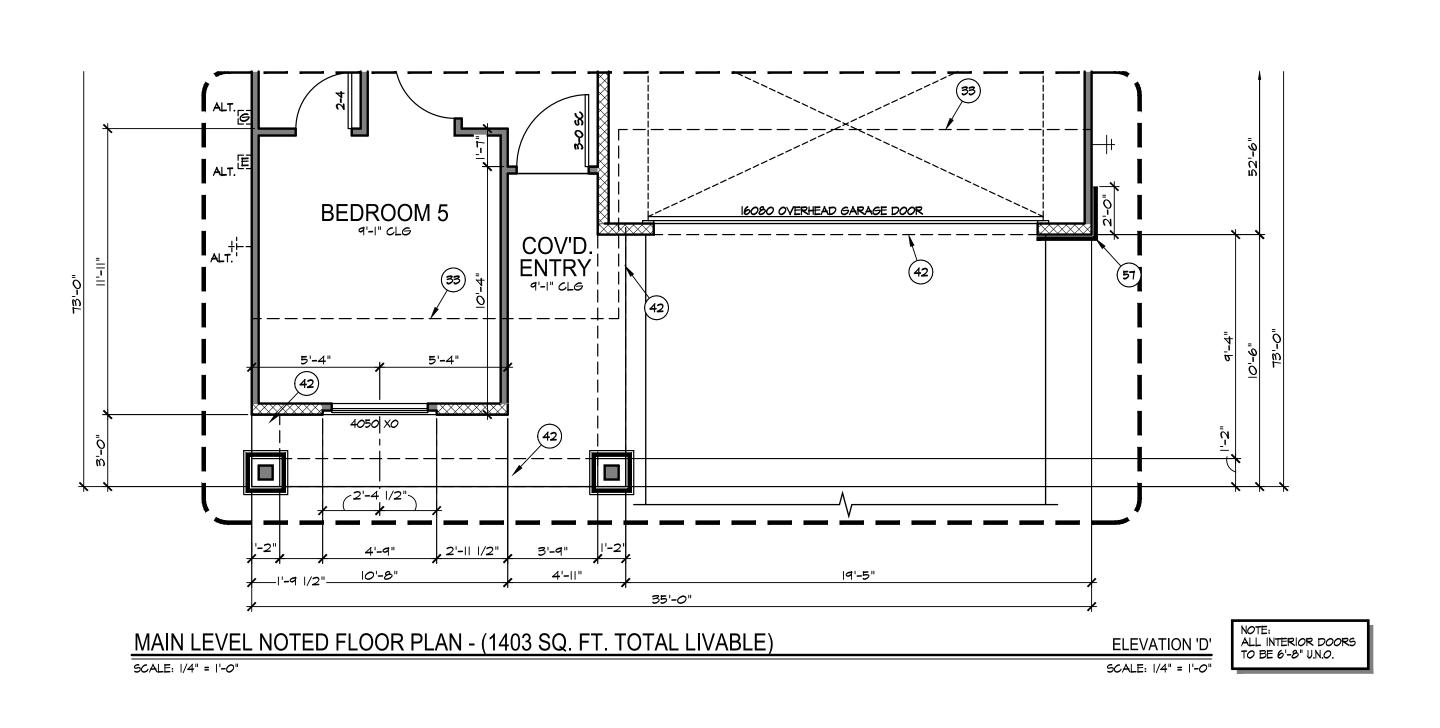
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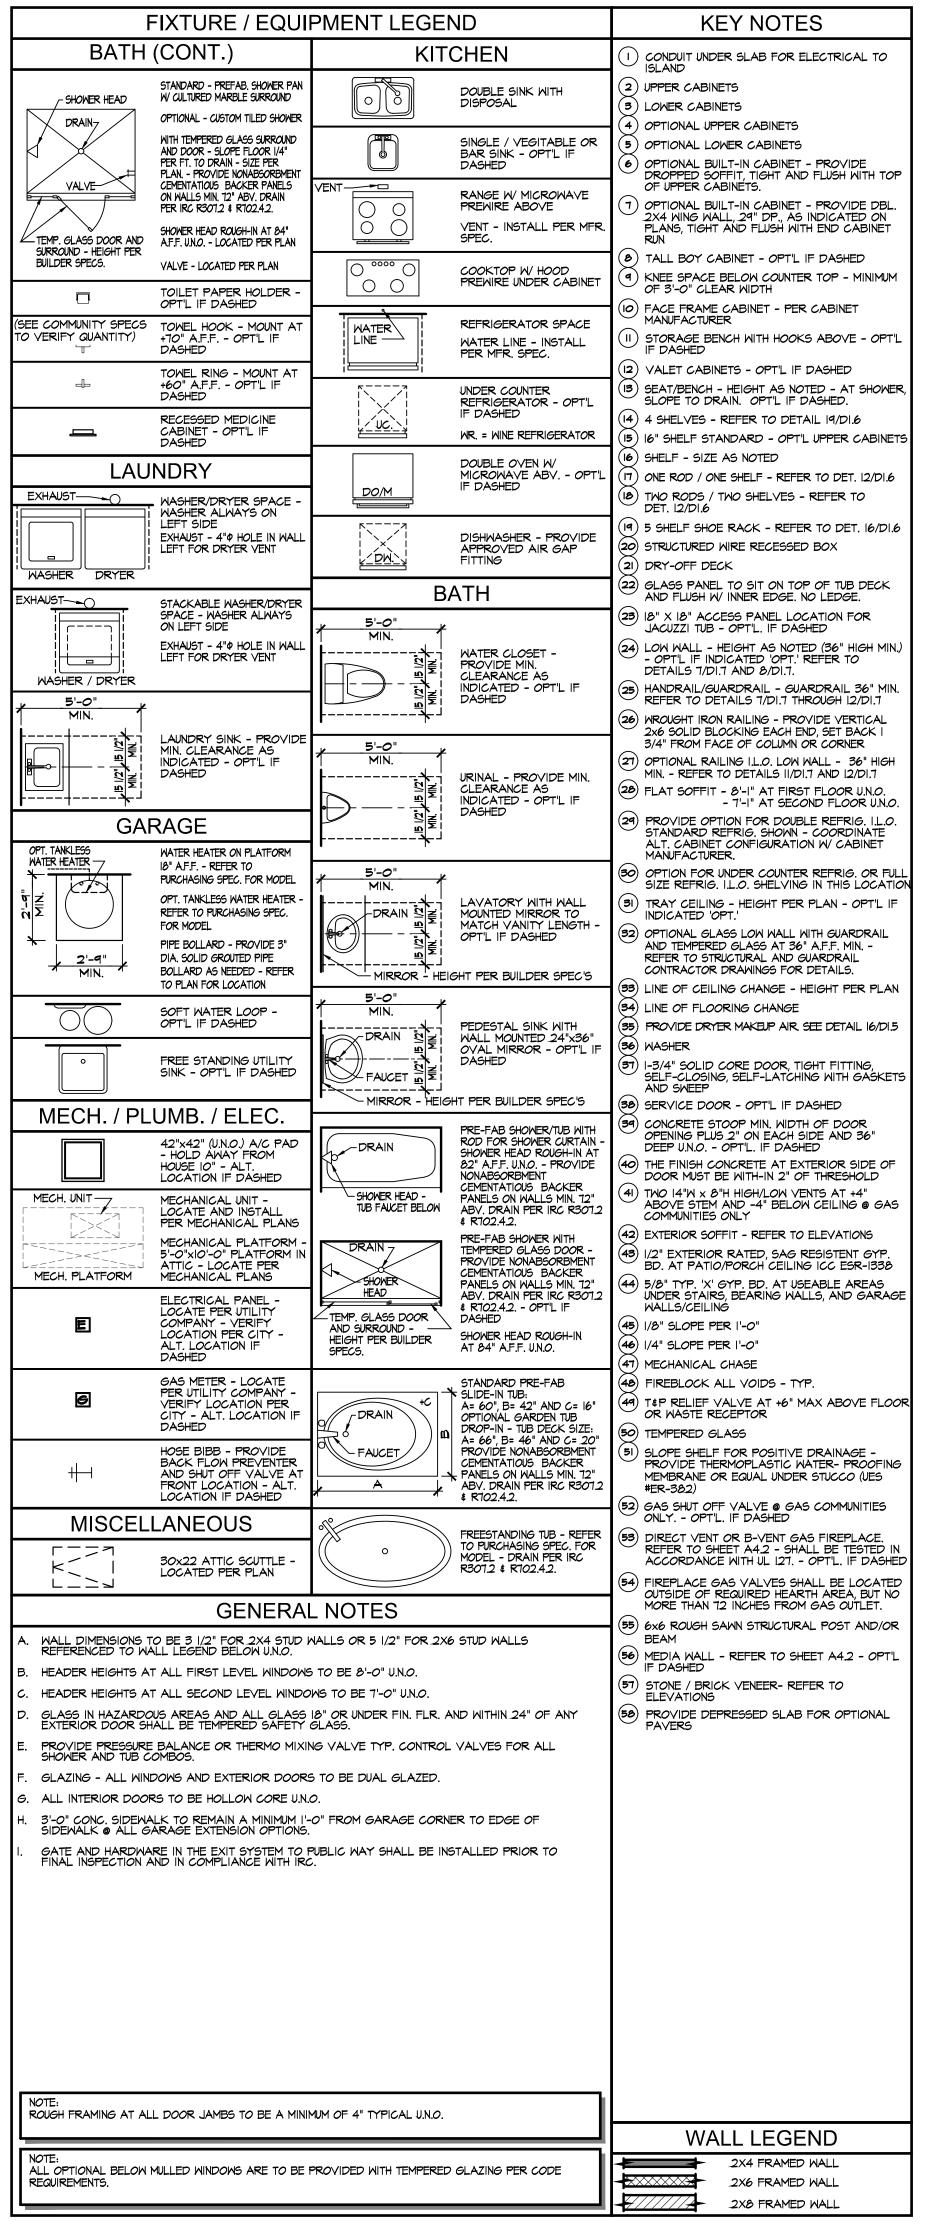
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MAIN LEVEL PARTIAL NOTED FLOO ELEVATIONS 'J' AND 'D'


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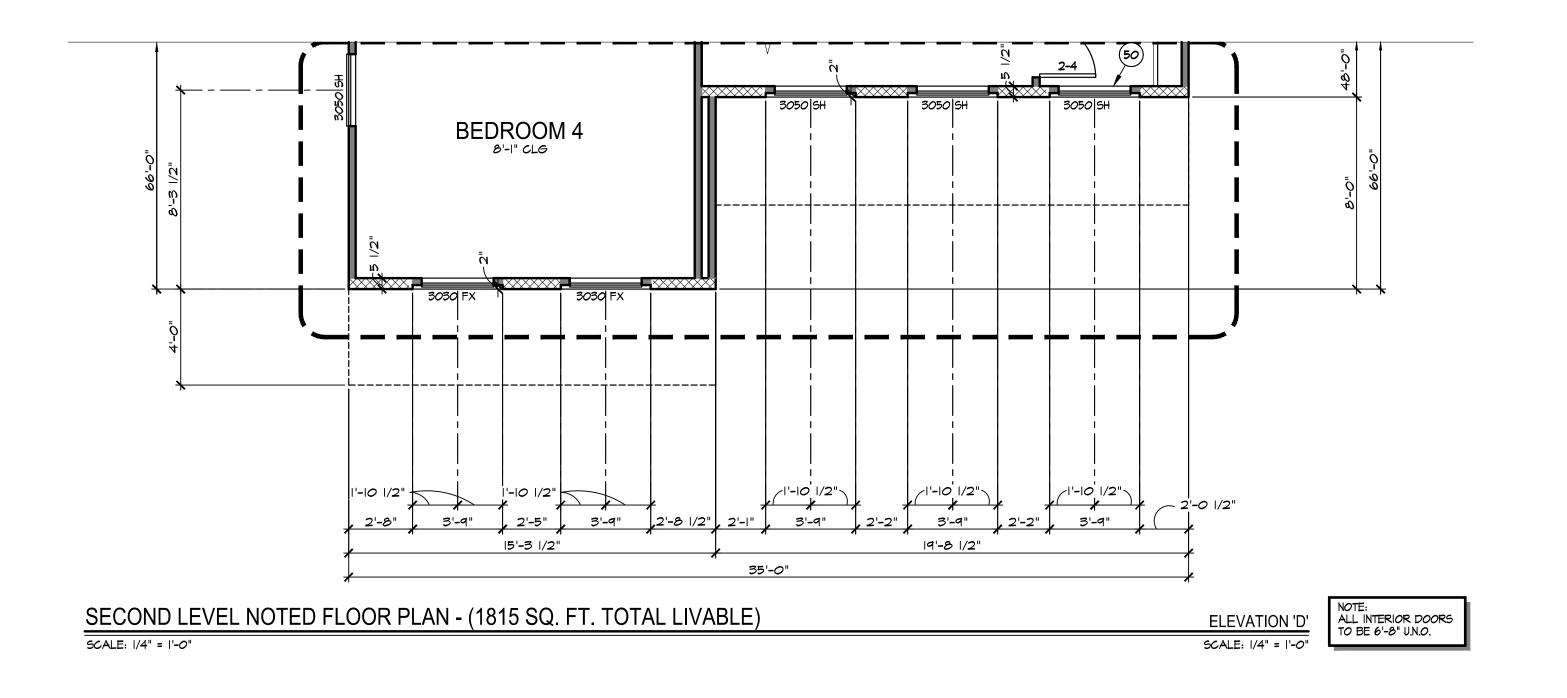



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SHEET No.

SCALE: 1/4" = 1'-0"





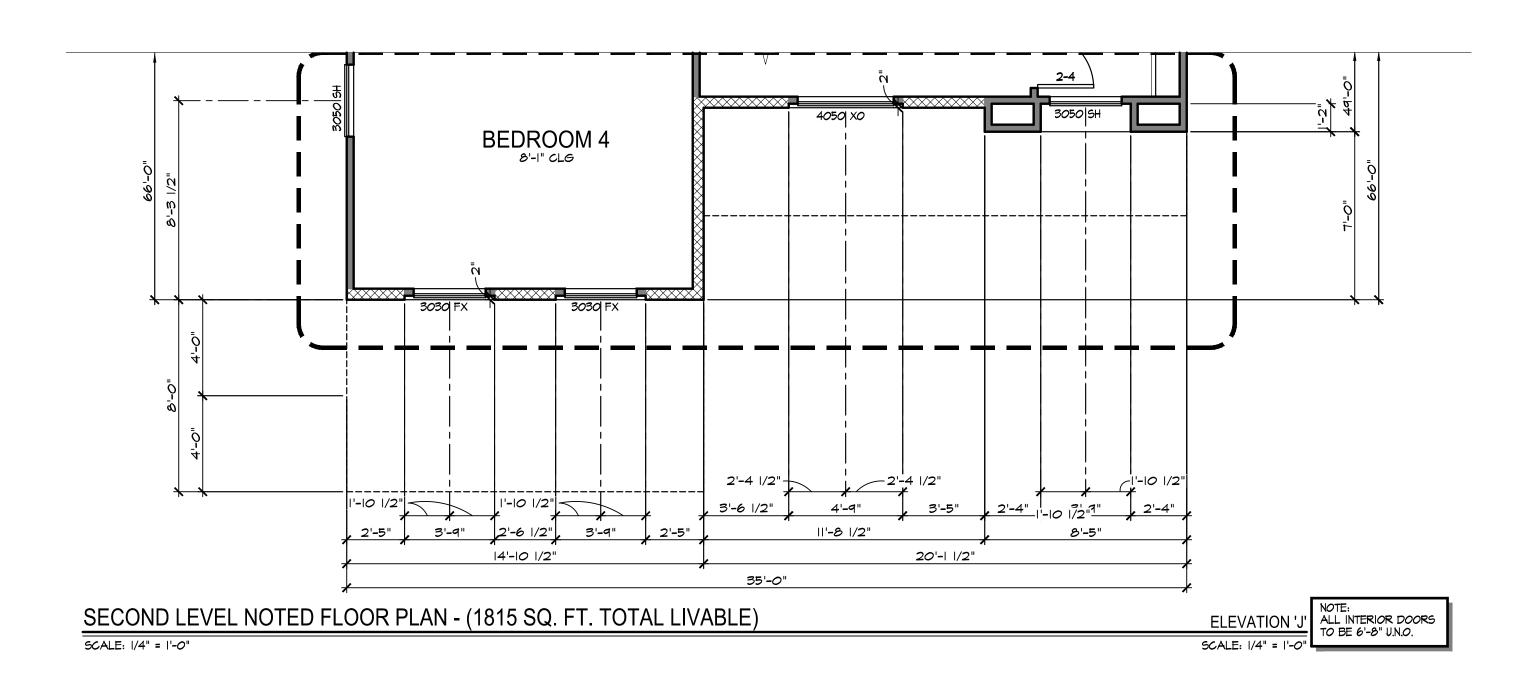
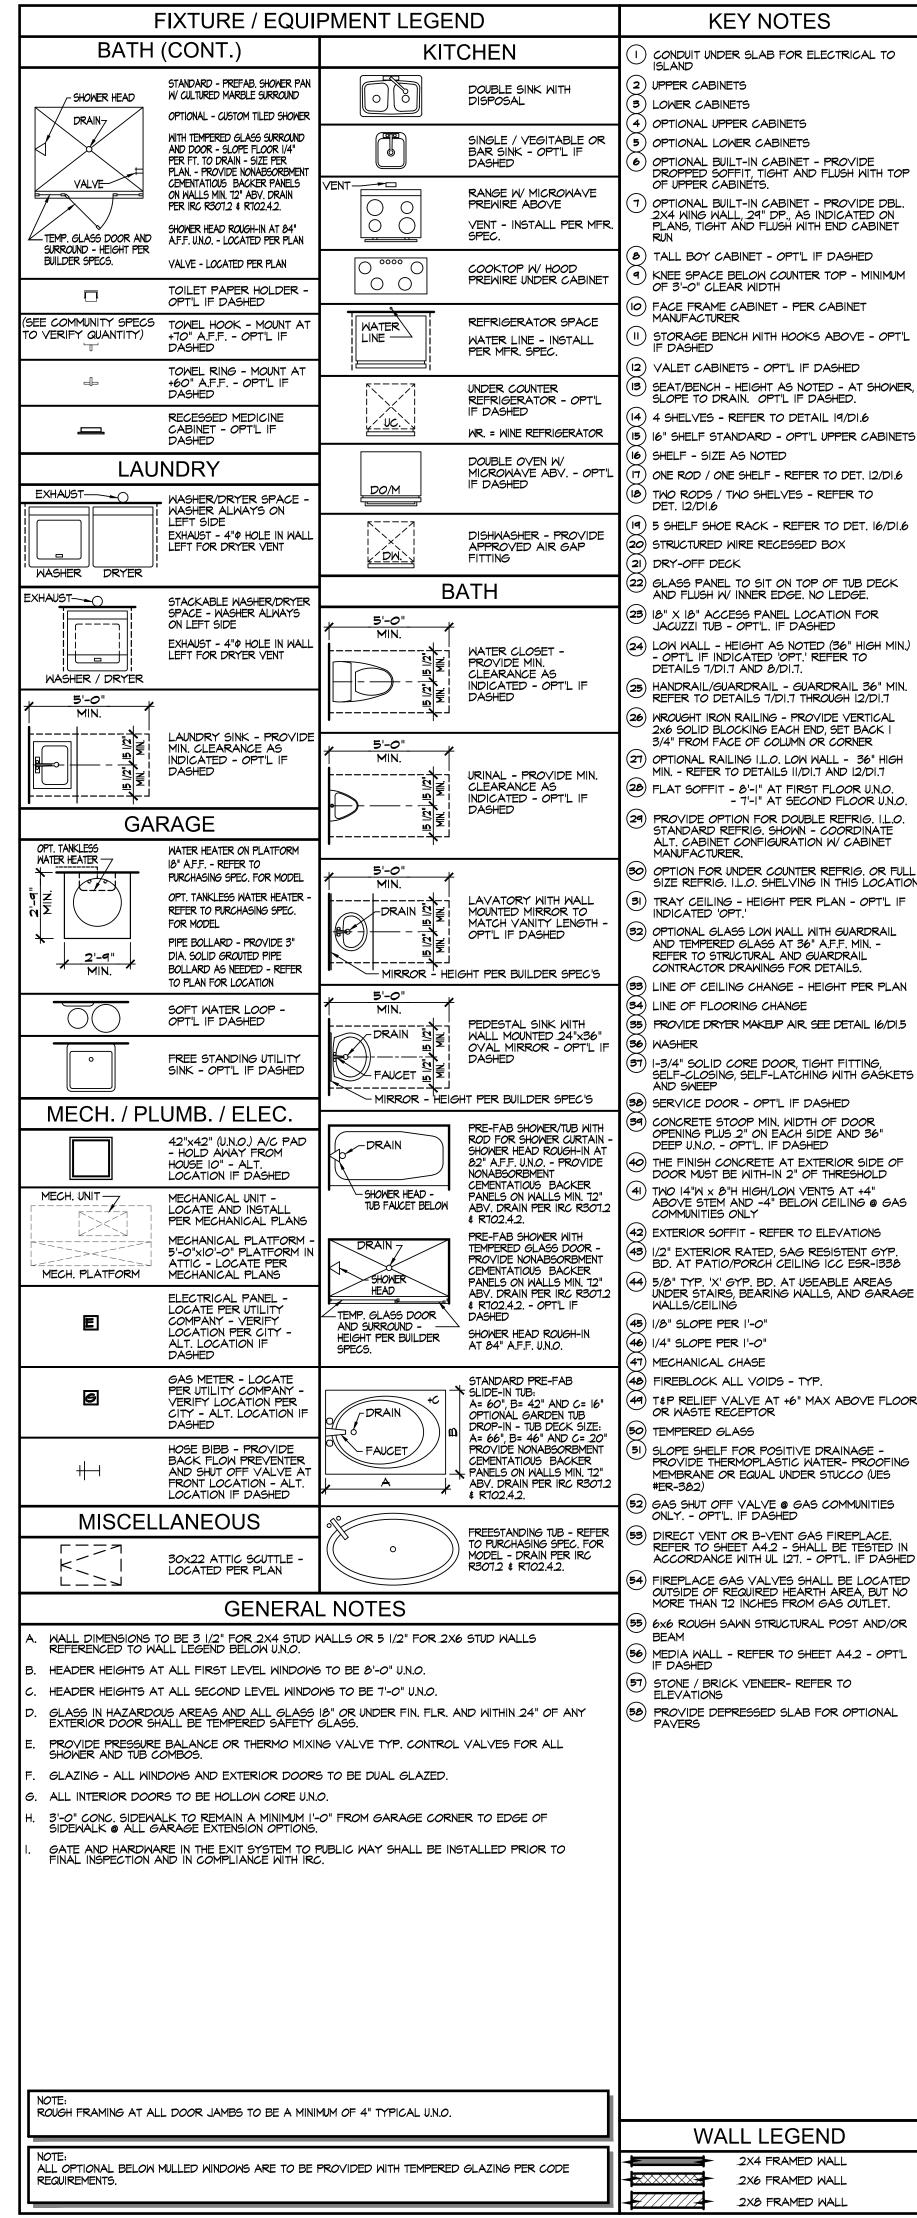
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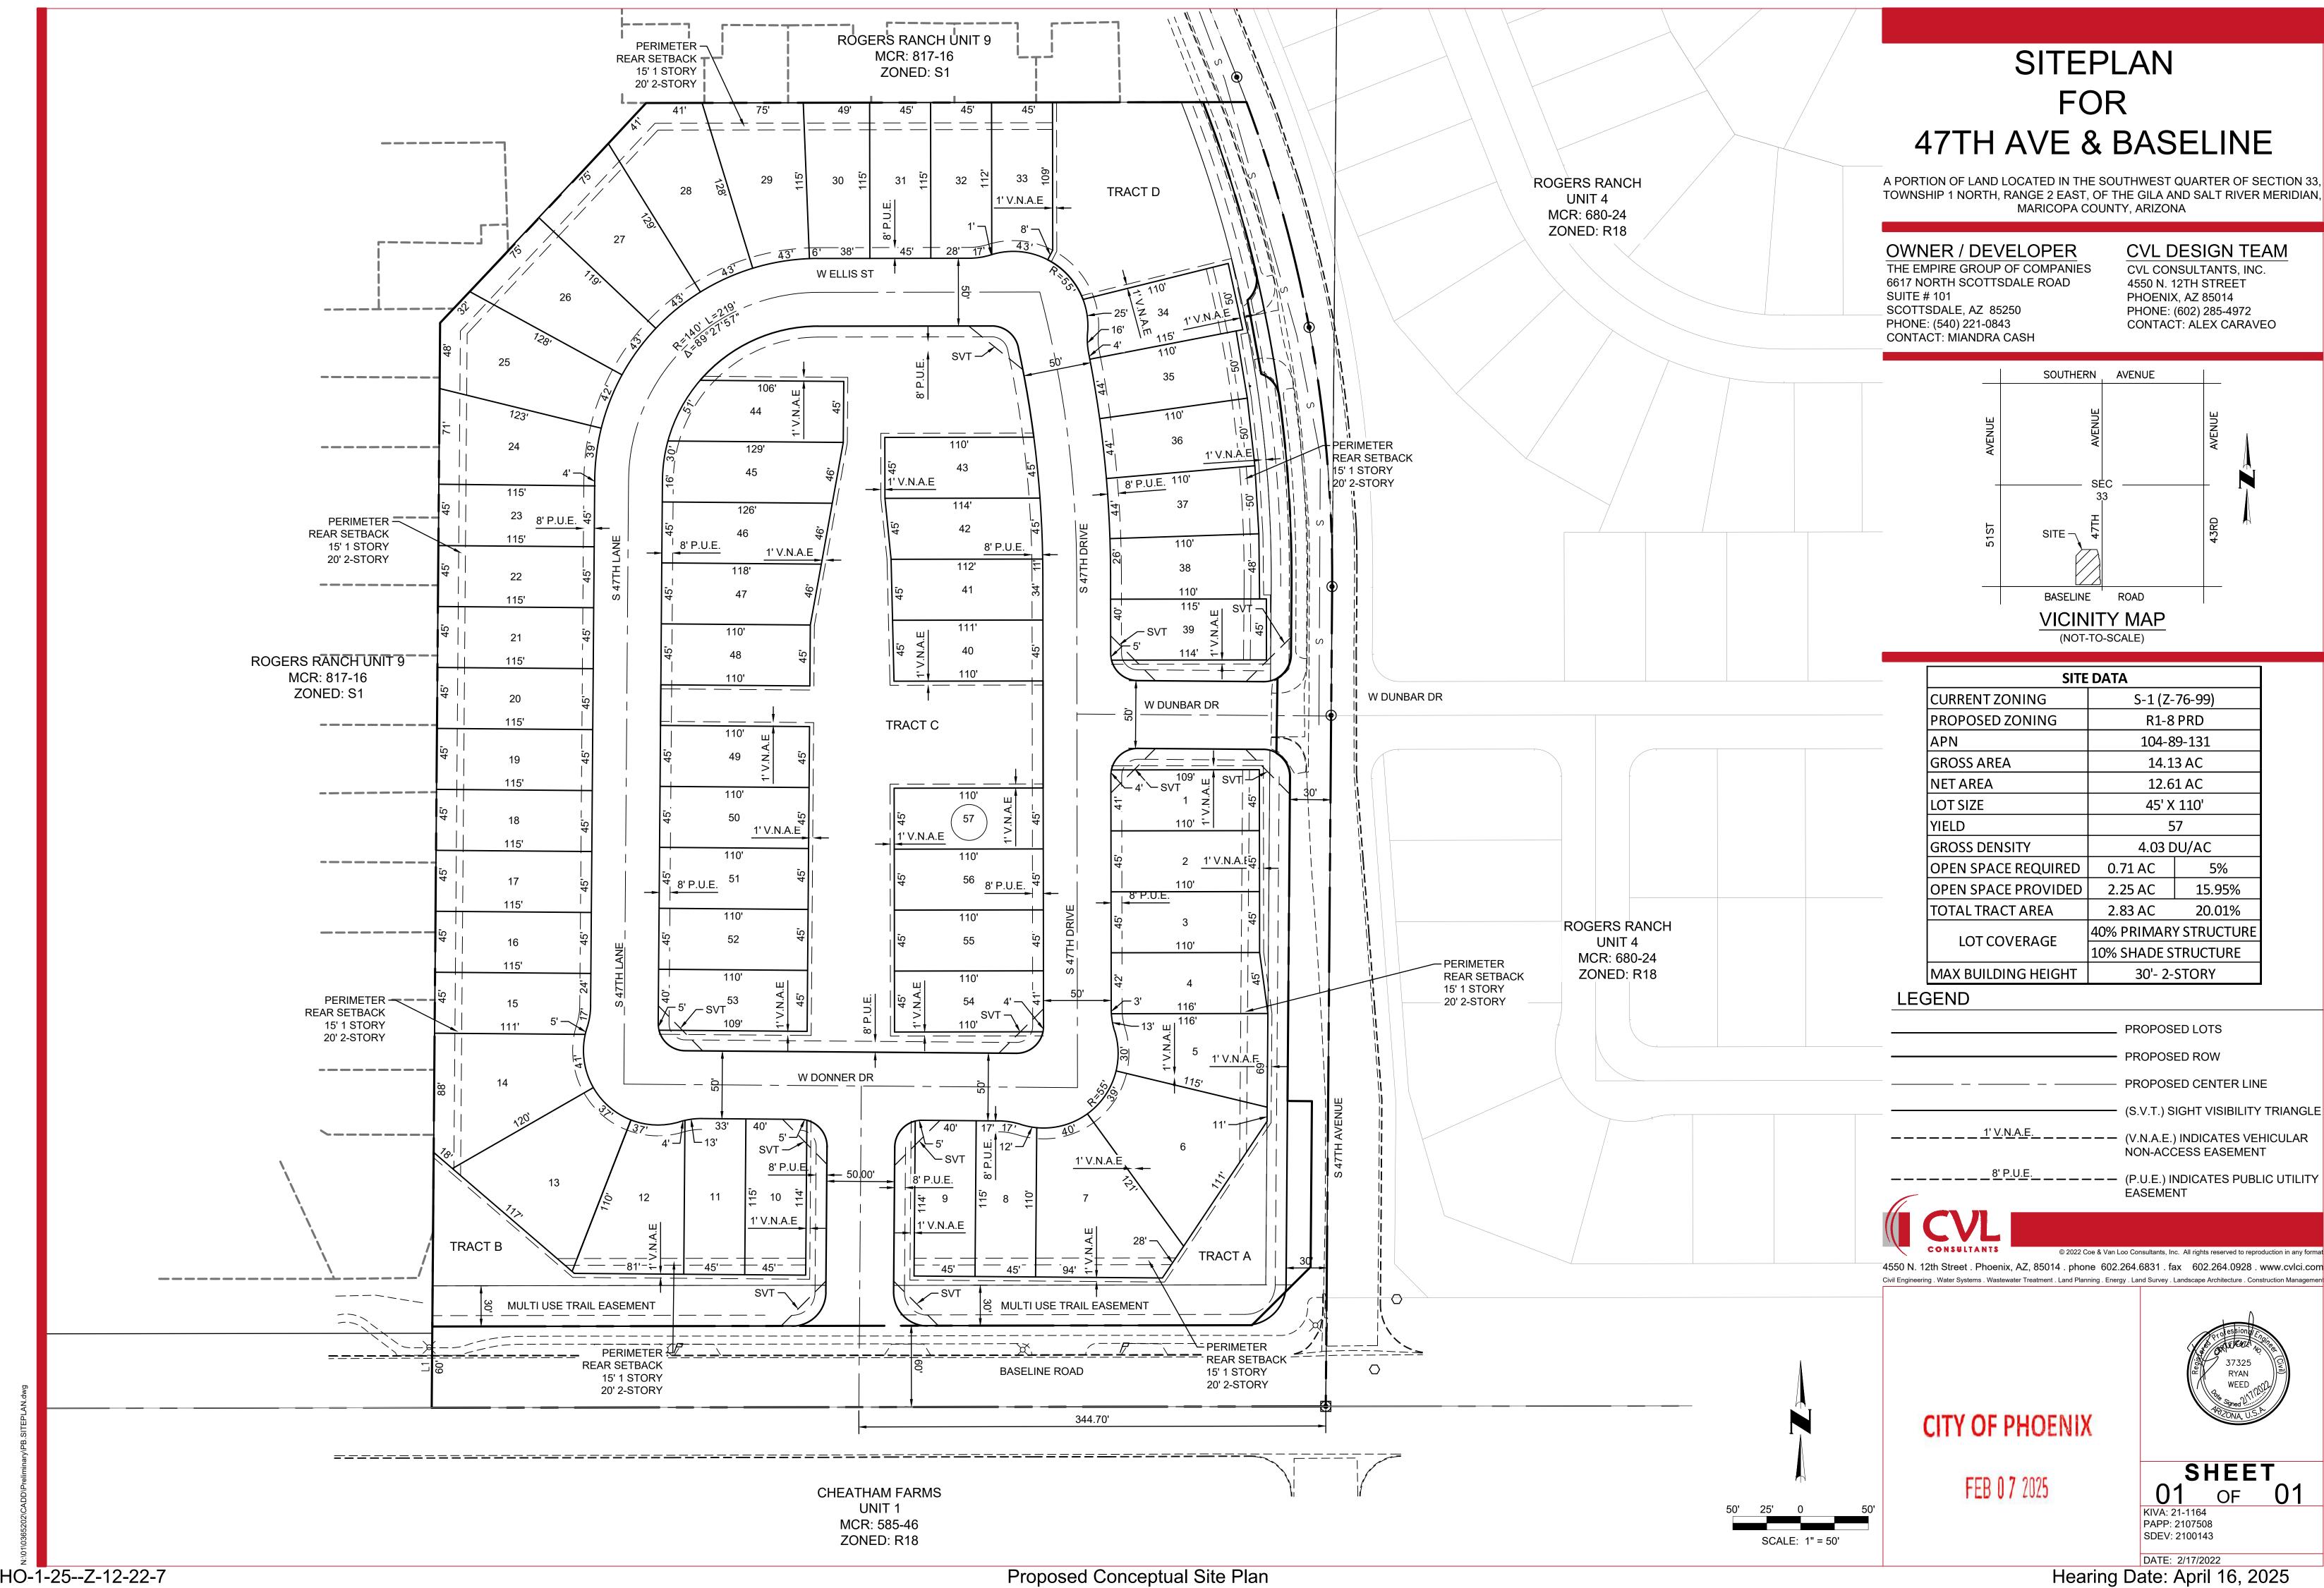
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PLAN# 3560



SHEET No.



Z-12-22-7 - Northwest Corner of 47th Avenue and Baseline Road (Ordinance G-6999)

Request to amend the Phoenix Zoning Ordinance, Section 601, the Zoning Map of the City of Phoenix, by adopting Rezoning Application Z-12-22-7 and rezone the site from S-1 (Ranch or Farm Residence District) to R1-8 (Single-Family Residence District) to allow single-family residential.

Summary

Current Zoning: S-1
Proposed Zoning: R1-8
Acreage: 14.07 acres

Proposed Use: Single-family residential

Owner: Rogers Family Living Trust

Applicant: Brennan Ray, Burch & Cracchiolo, P.A.

Representative: Brennan Ray, Burch & Cracchiolo, P.A.

Staff Recommendation: Approval, subject to stipulations.

VPC Action: The Laveen Village Planning Committee heard this case on May 9, 2022, and recommended approval with additional stipulations by a vote of 9-1.

PC Action: The Planning Commission heard this case on Jun. 2, 2022, and recommended approval per the staff memo dated Jun. 2, 2022, by a vote of 7-0.

Location

Northwest corner of 47th Avenue and Baseline Road.

Council District: 7

Parcel Address: 4702 W. Baseline Road.

This item was adopted.

Payment Ordinance for Blue Ridge Fire District (Ordinance S-48899)

For \$10,113.19 for annual payment authority for Blue Ridge Fire District to provide fire protection and/or EMS services to City-owned property in

City of Phoenix Page 192

14. **Application #: Z-12-22-7**

From: S-1 To: R1-8 Acreage: 14.07

Location: Northwest corner of 47th Avenue and Baseline Road

Proposal: Single-family residential

Applicant: Brennan Ray, Burch & Cracchiolo, P.A.

Owner: Rogers Family Living Trust

Representative: Brennan Ray, Burch & Cracchiolo, P.A.

Ms. Racelle Escolar stated that Item No. 14 is Z-12-22-7, a request to rezone 14.07 acres located at the northwest corner of 47th Avenue and Baseline Road from S-1 (Ranch or Farm Residence District) to R1-8 (Single-Family Residence District) to allow a single-family residential.

The Laveen Village Planning Committee recommended approval, per the staff recommendation with additional stipulations by a 9 to 1 vote. The additional stipulations were to:

- limit the building height for specific lots along Baseline Road and 47th Avenue.
- require minimum five-foot side yards setbacks, to
- require traffic calming measures within the subdivision, and
- require the installation of wiring for electric vehicle (EV) charging.

Ms. Escolar stated that a memo was released on this item today. It is posted on the City website. It modifies the stipulation related to the EV-Ready homes, to make it easier to enforce and allowing the future homeowner to decide if they want to build a home with the EV-Ready capability.

Staff recommends approval, per the staff memo dated June 2, 2022.

Ms. Escolar stated that there was one person who requested to speak, the Vice-Chair of the Laveen Village Planning Committee.

Ms. Linda Abegg, Vice-Chairwoman of Laveen Village Planning Committee stated that she made the motion for this case. Regarding EV (electric vehicle), she wanted the Planning Commission to consider that the applicant did agree to wiring for EV vehicles. The Village would like it to be something that is a standard for these homes. They are trying to look to the future, making sure they are sustainable in this big boom. By giving it as an Option A, right now, not many people have electric vehicles, and so they may not want to spend the amount the builder requires, to add that in to the cost of the home. That is not preparing for the future. They are trying to get that wiring installed ahead of the vehicles. It ends up being an upcharge most of them see in the new home builds, where you get to choose those new options. It is a lot more expensive for added options and it will be a deterrent to getting that EV installed.

Ms. Abegg stated that in this case, the applicant is agreeing to do something that is a City goal and an overall goal to save energy and support sustainability and the environment. They would appreciate if the stipulation could remain in place. She stated that no one involved has been opposed to it, except with regards to this City memo.

Chairwoman Mangum thanked Ms. Abegg for her service on the Village Planning Committee.

Ms. Escolar stated that if that is considered, the Planning Commission has the option to approve this item per the staff memo, with the modification of Stipulation No. 6 to delete the option. It would be required for all of the standard home plans.

Commissioner Perez responded that she also had conversations with the builder, and they were very willing and gracious. The memo felt too 'Lucy Goosey' for her taste and with what was stated by Ms. Abegg that they are preparing for the future. If they have an agreement by the home builders to do this, she is not sure why the City would not want to honor that. They appreciate them wanting to do that, in the first place. She requesting to keep the stipulation in there.

Vice-Chairman Gaynor asked Commissioner Perez if she would move to nullify the memo.

Commissioner Perez responded that she would nullify that stipulation and approve it per the Laveen Village Planning Committee recommendation, with their stipulation.

Commissioner Gorraiz asked if that would be just the removal of Stipulation No. 6.

Commissioner Perez responded that was correct. She asked Ms. Escolar to confirm.

Ms. Escolar stated that it would not be for the removal, but they could just approve it per the Laveen Village Planning Committee recommendation.

Commissioner Perez made a MOTION to approve Z-12-22-7, per the Laveen Village Planning Committee recommendation.

Vice-Chairman Gaynor SECONDED.

There being no further discussion, Chairwoman Mangum called for a vote and the MOTION Passed 7-0 (Howard, Johnson absent).

Stipulations:

- 1. The development shall be in general conformance to the site plan date stamped May 4, 2022, with specific regard to the following element, as approved by the Planning and Development Department.
 - a. A minimum of 16% of the gross site area shall be retained as open space.
- 2. The conceptual elevations shall be reviewed and approved by the Planning Hearing Officer through the public hearing process for stipulation modification prior to approval of the Single-Family Design Review Diversity Exhibit, with specific regard to the inclusion of the below elements. This is legislative review for conceptual purposes only. Specific development standards and requirements will be determined by the Planning Hearing Officer and the Planning and Development Department.
 - a. All elevations shall incorporate a minimum of three of the following architectural embellishments and detailing: textural changes, pilasters, offsets, recesses, variation in window size and location, and/or overhang canopies.
 - b. All elevations shall incorporate a minimum of three of the following building materials: native stone, burnt adobe, textured brick, wood (when shaded by overhangs or deep recesses), slump block, ceramic tile (matte finish), stucco, and/or exposed aggregate concrete.
 - c. The front elevations shall consist of a minimum 25% non-stucco accent material.
 - d. All garage doors shall have decorative embellishments such as window panels, added materials surrounding the door, and/or trellises.
 - e. A minimum of 75% of the standard elevations provided shall include patios and/or covered porches in the front yard at a minimum of 60 square feet in area and a depth of at least six feet, and clearly separated from the front yard with fencing, subject to the Phoenix Zoning Ordinance.
- 3. LOTS 7, 8, 9, AND 10 ALONG BASELINE ROAD SHALL BE LIMITED TO 26 FEET, AS APPROVED BY THE PLANNING AND DEVELOPMENT DEPARTMENT.
- 4. NO MORE THAN TWO TWO-STORY HOMES SHALL BE BUILT ADJACENT TO ONE ANOTHER ALONG 47TH AVENUE, AS APPROVED BY THE PLANNING AND DEVELOPMENT DEPARTMENT.
- 5. HOMES SHALL HAVE MINIMUM 5-FOOT-WIDE SIDE YARD SETBACKS.

- 6. THE DEVELOPER SHALL INSTALL WIRING WITHIN HOMES FOR ELECTRIC VEHICLE CAPABILITIES.
- 3. Required landscape setbacks shall be planted with minimum 50% 2-inch
- 7. caliper and 50% 3-inch caliper large canopy drought-tolerant trees, 20 feet on center or in equivalent groupings, with 5-gallon shrubs per tree, as approved by the Planning and Development Department.
- 4. The entry drives shall incorporate enhanced landscaping on both sides,
- 8. planted with a variety of at least three plant materials, as approved by the Planning and Development Department.
- 5. The developer shall dedicate a 30-foot-wide multi-use trail easement (MUTE)
- 9. along the north side of Baseline Road and construct a minimum 10-foot-wide multi-use trail (MUT) within the easement in accordance with the MAG supplement detail and as approved by the Planning and Development Department. Where conflicts or restrictions exist, the developer shall work with the Site Planning section on an alternate design through the technical appeal process.
- 6. A minimum 22-foot setback shall be provided to the front of garages,
- 10. measured from the back of the sidewalk, for each home in the development, as approved by the Planning and Development Department.
- 7. The developer shall dedicate 30 feet of right-of-way along the west side of
- 11. 47th Avenue, as approved by the Planning and Development Department.
- 8. The developer shall complete the west side of 47th Avenue to include a
- 12. minimum 5-foot-wide detached sidewalk and minimum 8-foot-wide landscape area located between the back of curb and sidewalk to match the northern limit of the site, as approved by the Planning and Development Department.
- 9. The developer shall replenish the existing streetscape along Baseline Road,
- 13. as approved by the Planning and Development Department.
- 10. Where sidewalks are detached along 47th Avenue, Baseline Road, and
- 14. internal to the site, the landscape area located between the sidewalk and back of curb shall be planted to the following standards, as approved by the Planning and Development Department:
 - a. Minimum 3-inch caliper, large canopy, single-trunk, shade trees placed a minimum of 25 feet on center or in equivalent groupings to provide a minimum of 75% shade on adjacent sidewalks.
 - b. Drought tolerant shrubs and vegetative groundcovers with a maximum mature height of 24 inches to provide a minimum of 75% live coverage at maturity.

- c. Where utility conflicts arise, the developer shall work with the Planning and Development on an alternative design solution consistent with a pedestrian environment.
- 11. The developer shall construct a clearly defined and shaded pedestrian
- 15. pathway providing access to the multi-use-trail along Baseline Road, as approved by the Planning and Development Department.
- 16. TRAFFIC CALMING MEASURES SHALL BE INSTALLED WITHIN THE DEVELOPMENT, AS APPROVED BY THE STREET TRANSPORTATION DEPARTMENT.
- 12. The developer shall construct all streets within and adjacent to the
- 17. development with paving, curb, gutter, sidewalk, curb ramps, streetlights, median islands, landscaping and other incidentals, as per plans approved by the Planning and Development Department. All improvements shall comply with all ADA accessibility standards.
- 13. The developer shall rebuild the bus stop pad along westbound Baseline Road
- 18. according to P1260 and P1258, unless stated otherwise by the Public Transit Department.
- 14. If determined necessary by the Phoenix Archaeology Office, the applicant
- 19. shall conduct Phase I data testing and submit an archaeological survey report of the development area for review and approval by the City Archaeologist prior to clearing and grubbing, landscape salvage, and/or grading approval.
- 15. If Phase I data testing is required, and if, upon review of the results from the
- 20. Phase I data testing, the City Archaeologist, in consultation with a qualified archaeologist, determines such data recovery excavations are necessary, the applicant shall conduct Phase II archaeological data recovery excavations.
- 16. In the event archaeological materials are encountered during construction, the
- 21. developer shall immediately cease all ground-disturbing activities within a 33-foot radius of the discovery, notify the City Archaeologist, and allow time for the Archaeology Office to properly assess the materials.

LAVEEN VILLAGE PLANNING COMMITTEE MEETING MINUTES

Monday, May 9, 2022 Meeting was held electronically via a video conferencing platform

MEMBERS PRESENT

Tonya Glass, Chair Linda Abegg, Vice Chair Francisco Barraza Toni Buggs Stephanie Hurd JoAnne Jensen Gizette Knight Carlos Ortega Rebecca Perrera Jennifer Rouse

MEMBERS EXCUSED

Elijah Flores
Gary Flunoy
Christopher Joseph

STAFF PRESENT

Julianna Pierre

1. Call to order, introductions, and announcements by Chair.

Vice Chair Linda Abegg called the Laveen Village Planning Committee meeting to order at 6:31 p.m. with a quorum of ten members present (seven members required for a quorum).

2. Review and approval of the April 11, 2022 meeting minutes.

MOTION

Committee member Toni Buggs made a motion to approve the April 11, 2022 minutes. The motion was seconded by Committee member Stephanie Hurd.

VOTE

10-0, motion passed; Committee members Glass, Abegg, Barraza, Buggs, Hurd, Jensen, Knight, Ortega, Perrera, and Rouse in favor.

3. Council District updates.

Maria Lopez, Chief of Staff in the District 7 (D7) Office, provided the following updates to the Committee:

- The D7 Office is working on grant applications and allocation of American Rescue Plan funds to revitalize communities and build infrastructure:
- The City is executing their Climate Action and Heat Response Plans and working with the D7 Office to ensure everyone across the City has access to resources. They are in the process of securing another \$600,000 for cooling towels, water, signage, etc. for local nonprofits;
- The D7 Office is aware of the complaints and issues at 51st Avenue and Baseline Road. Councilwoman Ansari has requested that the Deputy City Manager, Human Services Department, Neighborhood Services Department,

Laveen Village Planning Committee

Minutes – May 9, 2022 Page 2 of 7

Parks and Recreation Department, and Police Department work together to provide resources to residents and continue work on the problem;

- Renderings for the 71st Avenue and Meadows Loop Park were seen by D7
 Office and it looks great and will be a great addition to the area;
- The D7 Office is working with the Economic Development team on a summer restaurant tour;
- Construction on the Cesar Chavez Community Center will be completed June 1, 2022 and the grand opening should be on August 1, 2022.
- 4. Public comments concerning items not on the agenda.

Dan Penton discussed the proposed IDM Smith Tech Park. He expressed concerns with the proposal to rezone to A-1, the Light Industrial Zoning District. He stated that this is not an area where the Village would want to have industrial zoning and the applicant should propose a Planned Unit Development (PUD) instead.

Phil Hertel indicated that he wished to speak, but could not access the meeting.

5. **INFORMATION ONLY:** Presentation and discussion regarding the electric vehicle roadmap.

Lisa Perez, Planning Commission and Electric Vehicle (EV) Ad Hoc Committee member, explained that the explained that the Ev Ad Hoc Committee was established in June 2021 and tasked to develop an EV roadmap. She added that the committee was a response to the City's Climate Action Plan and will end June 2022 with finalization of the roadmap. She and Mark Hartman, Chief Sustainability Officer, reviewed the EV Ad Hoc Committee's draft recommendations: support accelerated EV adoption in the community; expand access to public EV charging; and support access to home, business, and workplace charging; pilot mobility options in an underserved community.

QUESTIONS FROM COMMITTEE

Committee member Stephanie Hurd stated that as technology shifts, it is important to implement the appropriate infrastructure. She asked for clarification regarding the charging speed. Mark Hartman stated that most people driving 10 to 15 miles can use a Level 1 charging station. He added that Level 2 charging stations allow more miles, but can take 6 to 8 hours to fully charge. He stated that the newest DC Fast charging stations can provide full charge in less than 30 minutes. He stated that there are plans to have fast charging stations every 50 miles along interstate highways. Committee member Stephanie Hurd asked about the chargers in Cesar Chavez Park. Mark Hartman stated that they are fast charging stations.

Committee member Stephanie Hurd asked about the type of charging stations that should be requested within residential developments. Mark Hartman stated that Level 2 chargers are common in residences and that it is important to consider what infrastructure is necessary as EVs become more common. Lisa Perez added that it is

important to encourage developers to provide infrastructure in advance, particularly within multifamily developments.

Chair Tonya Glass asked for clarification regarding policy implementation related to EVs. Lisa Perez stated that after all the recommendations are provided to the Ad Hoc Committee, they will move towards implementing policy. She added that there may also be additional requirements regarding retrofitting. Mark Hartman stated that EV requirements are expected to be in the building code by 2025.

Chair Tonya Glass asked for clarification regarding grid capacity. Mark Hartman stated that the City is currently using about 50% of the grid's capacity. He added that EV charging could be provided to every home in the City, as long as charging took place off peak during the summer months. Committee member Carlos Ortega provided an anecdote about EVs that are programmed to charge at the most opportune time.

Committee member Carlos Ortega asked if the Ad Hoc Committee met with other cities. Mark Hartman stated that the committee referenced EV plans from other cities and found 12 that were comparable to the City of Phoenix. Committee member Carlos Ortega asked if there is a way to implement EV policy sooner rather than later. Mark Hartman explained that it is possible depending on the EV market. He added that it would also take time to change the building code and train inspectors. Lisa Perez added that as the technology changes, documents are likely to change as well. Mark Hartman noted that the Ad Hoc Committee has an upcoming meeting where he can share the Village Planning Committee (VPC) suggestions and recommendations.

Vice Chair Linda Abegg stated that specific language could be helpful for the VPCs when creating stipulations for cases. She noted the importance of using the correct technical terminology when discussing wiring, levels, conduits, and other components. Chair Tonya Glass added that this language could be used at pre-application meetings, so developers understand expectations early in the rezoning or development process.

Committee member Carlos Ortega stated that the Ad Hoc Committee should revisit the master planning process and determine a way to include EV charging. Mark Hartman stated that they intend to include EV charging in both General and Village plans. Lisa Perez added that EV charging will become embedded in all future processes.

PUBLIC COMMENTS

Dan Penton explained that installation of EV charging by residents has barriers to entry related to time and finances. He added that EV charging is expected to become a major part of infrastructure, but eventually the grid will be at capacity and instead there should be an integration of solar energy into EV charging. He added that EV charging stations should be incorporated at gas stations with solar panels atop fuel canopies. He added that there should be innovative ways to recycle EV batteries and

solar cells, include EV charging in multifamily development, and retrofit commercial parking lots to include charging stations. **Mark Hartman** stated that those recommendations align with the thinking of the Ad Hoc Committee. He added that the committee is thinking of ways to streamline the permitting process and pair solar and EV charging.

6. Z-12-22-7: Presentation, discussion, and possible recommendation on a request to rezone 14.07 acres located at the northwest corner of 47th Avenue and Baseline Road from S-1 (Ranch or Farm Residence) to R1-8 (Single-Family Residence District) to allow single-family residential.

STAFF PRESENTATION

Julianna Pierre provided information regarding the location of the site, surrounding zoning, and general plan land use designation. She stated that the proposal is to rezone the site from S-1 to R1-8 to allow a single-family residential subdivision. She added that the development is proposed to have 55 single-family detached lots with ingress and egress to both 47th Avenue and Baseline Road. She added that no elevations were submitted with the application. She reviewed the staff findings and stipulations. She stated that staff is recommending approval, subject to stipulations. She added that the applicant is suggesting two additional stipulations: 1) Lots 7, 8, 9, and 10 along Baseline Road shall be limited to 26 feet, as approved by the Planning and Development Department and 2) No more than two two-story homes shall be built adjacent to one another along 47th Avenue, as approved by the Planning and Development Department.

APPLICANT PRESENTATION

Brennan Ray, representative with Burch & Cracchiolo, P.A., stated that in May 2021 this request was informally brought before members of the Laveen VPC and Laveen Citizens for Responsible Development (LCRD) for comments. He added that the original proposal was for 147 rental units, which was determined to not be appropriate for the site. The proposal was revised to 57 single-family detached lots. Based on the neighborhood meeting and LCRD comments, there were additional revisions to the plan including: reduction to 55 lots, modification of ten lots to be 50 feet wide, and an increase of open space. He added that the location is a challenging infill site and economics would not allow for all lots to be modified to 50 feet wide.

Brennan Ray discussed the multiuse trail (MUT) and multiuse trail easement (MUTE) requirements along Baseline Road. He added that based on LCRD comments and discussions they are proposing two additional stipulations regarding height limitations to Lots 7, 8, 9, and 10 and limitations to two-story homes. He added that there had been questions about traffic and a deceleration lane, but a traffic engineer determined that there is not enough volume to warrant a right turn lane.

QUESTIONS FROM COMMITTEE

Committee member Jennifer Rouse asked about the sidewalk along Baseline Road, cut through traffic, and speed mitigation measures. Brennan Ray explained the

rendering shown was inaccurate and there would be a sidewalk along Baseline Road. He added that the development will not be gated and internal streets will be public, but the development is open to traffic calming measures. **Committee member Jennifer Rouse** asked if the lighting will be adequate. **Brennan Ray** explained that the development's lighting will comply with the City Ordinance.

Committee member Carlos Ortega explained that 45-foot-wide lots are not wanted in the neighborhood. Brennan Ray explained that since this was an infill site, which lends itself to more intense development, which is why a mix of 50- and 45-foot-wide lots was being proposed. He added that the development's density is consistent with the area.

Vice Chair Linda Abegg asked for clarification regarding Stipulation No. 6, regarding a setback to the front of the garage. She stated that the language was different from prior stipulations regarding the 22-foot-long driveways. Julianna Pierre explained during the review process, the language was modified to have standard enforceable language.

Vice Chair Linda Abegg requested an additional stipulation requiring all side yards to be at least 5 feet wide. Committee member Carlos Ortega asked about 10 feet between rooftops. Vice Chair Linda Abegg explained that asking for 5-foot-wide side yards would get the same result. Brennan Ray stated that he had no concerns with an additional stipulation.

Chair Tonya Glass stated that an EV stipulation should be considered. Brennan Ray conferred with his team and stated that they could commit to wiring homes for EV capabilities. Julianna Pierre explained that an EV stipulation may not be enforceable. She noted that stipulations should be something that can be shown on a site plan and evaluated for compliance through Site Planning's review process. The Committee agreed that they would prefer to have a stipulation regarding EV requirements in their recommendation and if not enforceable, Planning Commission could remove the stipulation.

Vice Chair Linda Abegg requested an additional stipulation regarding speed mitigation. Brennan Ray stated that he had no concerns with an additional stipulation.

PUBLIC COMMENTS

Two members of the public indicated that they wanted to speak. However, there were no public comments for this item as **Dan Penton** had to leave the meeting and **Phil Hertel** could not access the meeting.

MOTION

Chair Linda Abegg made a motion to approve Z-12-22-7 with the following additional stipulations:

1. Lots 7, 8, 9, and 10 along Baseline Road shall be limited to 26 feet, as approved by the Planning and Development Department.

Page 6 of 7

- 2. No more than two two-story homes shall be built adjacent to one another along 47th Avenue, as approved by the Planning and Development Department.
- 3. Homes shall have minimum 5-foot-wide side yard setbacks.
- 4. Traffic calming measures shall be installed within the development, as approved by the Street Transportation Department.
- 5. The developer shall install wiring within homes for electric vehicle capabilities.

The motion was seconded by Committee member Stephanie Hurd.

VOTE

9-1, motion passed; Committee members Glass, Abegg, Barraza, Buggs, Hurd, Jensen, Knight, Perrera, and Rouse in favor and Committee member Ortega in opposition.

7. Staff update on cases recently reviewed by the Committee.

Julianna Pierre provided the following updates:

- PHO-1-22—Z-51-08-7: (Southeast corner of 35th Avenue and Southern Avenue) Modification and deletion of stipulations to allow a residential development. The Planning Hearing Officer recommended approval, with modifications and additional stipulations on April 20, 2022.
 - A modification to Stipulation No. 1 to accommodate the site plan presented at the April VPC meeting.
 - A modification to Stipulation 1 and additional stipulation to split the conformance requirements for the site plan and elevations into separate stipulations.
 - A modification to Stipulation No. 3 to provide more standards language for the conformance requirement and to identify the applicant's proposal for landscape islands as an item for specific regard.
 - A modification to Stipulation No. 5 to allow greater flexibility in reviewing how the stipulation is being implemented; specifically removal of references to the commercial development, which is no longer planned, and clarification that pathway shading can be accomplished through landscaping or architectural features.
 - A modification to Stipulation No. 12 to split the maximum unit count and building height restriction into two separate stipulations.
- Additional stipulations from the Street Transportation Department: 1)

 A requirement for the developer to replenish the detached landscape strips along 35th Avenue, 2) A requirement for the developer to provide a minimum of 20 bicycle parking spaces, 3)A requirement for an enhanced and shaded pedestrian pathway to the bus stop along 35th Avenue.

Laveen Village Planning Committee Minutes – May 9, 2022 Page 7 of 7

- A reminder that Diana Hernandez sends out the VPC packets prior to the monthly meeting and that her email contains a link for quorum checks.
- 8. <u>Committee member announcements, requests for information, follow up, or future</u> agenda items.

Chair Tonya Glass inquired about returning to in person meetings.

Committee member Jennifer Rouse congratulated Vice Chair Linda Abegg on her award as a Laveen Legend. She stated that the Laveen Car Show, that took place at 35th Avenue and Southern Avenue, was successful. She added that there is a meeting tomorrow regarding 51st Avenue and Baseline Road.

Committee member Rebecca Perrera stated that on Saturday from 9AM to 12PM in Cesar Chavez Park, the Laveen Action Committee and Chamber of Commerce are putting together 60 booths for a Youth Leadership Summit.

Committee member Francisco Barraza stated that the craft fair is slowing down due to the host being injured. He added that the last day of school is upcoming and to look forward to preparations for the upcoming school year.

Chair Tonya Glass congratulated Vice Chair Abegg on her accolades and impact on the community with her park related pursuits. Committee member Carlos Ortega asked when the parks will be completed. Vice Chair Linda Abegg stated that the park at 55th Avenue and Samantha Way is still waiting for building permits and the park at 71st Avenue and Meadows Loop is going to the Parks Board this month to have their plan approved.

Committee member Carlos Ortega expressed concerns regarding homeless at bus stops. He requested a presentation about how to mitigate the homeless loitering at bus stops. Chair Tonya Glass added that it may be beneficial to work with Councilwoman Ansari regarding the issue.

9. Adjournment.

Committee member Jennifer Rouse made a motion to adjourn the meeting. The motion was seconded by Committee member Carlos Ortega.

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The meeting was adjourned at 8:41 p.m.